


PROPOSED SITE PLAN MODIFICATIONS FOR



NEIGHBORHOOD MARKET #4563-00
NWC SHERIDAN ST. AND SE 5TH AVE.
401 E. SHERIDAN STREET
DANIA BEACH, FL 33004
PCN: 514203 6000 10



RECEIVED
 JUN 18 2015
 Planning Department

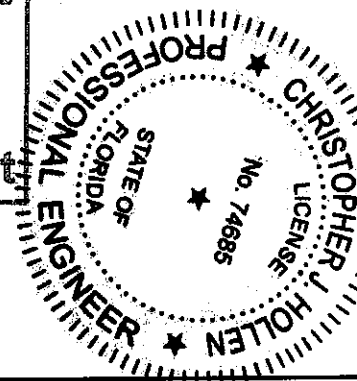

Kimley-Horn
 2015 KIMLEY-HORN AND ASSOCIATES, INC.
 449 20TH STREET, SUITE 200, VERO BEACH, FL 32960
 PHONE: 772-794-4100
 WWW.KIMLEY-HORN.COM

UTILITY RESPONSIBILITY MATRIX FOR THIS PROJECT

TELEPHONE	UTILITY GOVERNING AGENCIES CONTACTS	CONTRACTOR RESPONSIBILITY	OTHERS RESPONSIBILITY	WALMART UTILITY CONTACT
AT&T 4000 SW 11TH AVE. PLANTATION, FL 33322 CONTACT: EDUARDO BARRA PHONE: (954) 476-2794		<ul style="list-style-type: none"> COORDINATE CONSTRUCTION ACTIVITIES WITH TELEPHONE COMPANY TO ENSURE INSTALLATION OF UNDERGROUND LINES ARE COMPLETED PRIOR TO ASPHALT OR CURB PLACEMENT PROVIDE AND INSTALL 2" SCHEDULE 40 PVC CONDUITS WITH PULL ROPES, INCLUDING ALL TRENCHING AND BACKFILLING, FROM THE RISER POLE UP TO THE BUILDING PROVIDE AND INSTALL PULL BOXES AS PER TELEPHONE COMPANY REQUIREMENTS 	<ul style="list-style-type: none"> TELEPHONE COMPANY WILL PROVIDE AND INSTALL ALL TELEPHONE CABLES FROM THE POINT OF CONNECTION UP TO THE BUILDING PRESENT RESPONSIBLE PARTIES ANY RELOCATION OF EXISTING WILL BE DONE BY AT&T. PRESENT RESPONSIBLE PARTIES 	TELECOM DEPT. (479) 277-9597
FPL 4000 DANIE RD. EXT. HOLLYWOOD, FL 33024 CONTACT: DAVID GILL PHONE: (954) 442-6561		<ul style="list-style-type: none"> COORDINATE CONSTRUCTION ACTIVITIES WITH ELECTRIC COMPANY TO ENSURE INSTALLATION OF UNDERGROUND LINES ARE COMPLETED PRIOR TO ASPHALT OR CURB PLACEMENT PROVIDE AND INSTALL 2" SCHEDULE 40 PVC CONDUITS WITH PULL ROPES, INCLUDING TRENCHING AND BACKFILLING, FOR THE UNDERGROUND PORTIONS OF THE PRIMARY FROM THE RISER POLE UP TO THE TRANSFORMER SCHEDULE 40 PVC CONDUITS SHALL BE USED ON THE RISER POLE AND RIGID METAL LONG RADIUS ELBOWS SHALL BE USED WHERE THE UNDERGROUND PORTION MEETS THE RISER POLE AND TRANSFORMER CONSTRUCT TRANSFORMER PAD AS PER FPL'S SPECIFICATIONS PROVIDE AND INSTALL ALL SECONDARY SERVICE AND MATERIALS 	<ul style="list-style-type: none"> ELECTRIC COMPANY WILL PROVIDE AND INSTALL ALL MATERIALS NEEDED TO ESTABLISH PRIMARY SERVICE FROM POINT OF CONNECTION AT THE EXISTING LINE UP TO THE TRANSFORMER PRESENT RESPONSIBLE PARTIES ELECTRIC COMPANY WILL PROVIDE AND INSTALL PRIMARY CABLE FOR ALL UNDERGROUND LINES UP TO THE TRANSFORMER PRESENT RESPONSIBLE PARTIES ANY RELOCATION OF EXISTING LINES OR POLES WILL BE DONE BY FPL. 	ENERGY MANAGEMENT DEPT. (479) 204-0452
CITY OF DANIA BEACH PUBLIC SERVICES 1201 STIRLING ROAD DANIA BEACH, FL 33004 PHONE: (954) 924-3741		<ul style="list-style-type: none"> PROVIDE AND INSTALL SANITARY SEWER LINES AND ASSOCIATED APPURTENANCES PER THE PLANS AND SPECIFICATION ALL PUBLIC AND PRIVATE SANITARY SEWER LINES SHALL BE PVC AND RATED FOR 28" COORDINATE REQUIRED INSPECTION SERVICES WITH ENGINEER OF RECORD AND CITY OF DANIA BEACH DEPARTMENT OF PUBLIC WORKS. SEE UTILITY PLAN FOR REQUIREMENTS. 		ENERGY MANAGEMENT DEPT. (479) 204-0452
CITY OF DANIA BEACH PUBLIC SERVICES 1201 STIRLING ROAD DANIA BEACH, FL 33004 PHONE: (954) 924-3741		<ul style="list-style-type: none"> PROVIDE AND INSTALL ALL WATER MAINS AND ASSOCIATED APPURTENANCES PER THE PLANS AND SPECIFICATION ALL PUBLIC AND PRIVATE WATER MAINS SHALL BE C-900 PVC, DR14 CLASS 200 ALL PORTIONS OF THE FIRE PROTECTION WATER SYSTEM SHALL BE INSTALLED BY A LICENSED FIRE SPRINKLER CONTRACTOR ALL PORTIONS OF OTHER NON FIRE PROTECTION RELATED LINES MAY BE INSTALLED BY THE PLUMBING CONTRACTOR COORDINATE REQUIRED INSPECTION SERVICES WITH ENGINEER OF RECORD AND CITY OF DANIA BEACH DEPARTMENT OF PUBLIC WORKS. SEE UTILITY PLAN FOR REQUIREMENTS. 	<ul style="list-style-type: none"> SETTING OF METER WILL BE BY THE CITY OF DANIA BEACH PRESENT RESPONSIBLE PARTIES ANY RELOCATION OF EXISTING WILL BE DONE BY CITY OF DANIA BEACH PUBLIC WORKS. PRESENT RESPONSIBLE PARTIES 	ENERGY MANAGEMENT DEPT. (479) 204-0452
BROWARD COUNTY EPD 1 N. UNIVERSITY DR., SUITE 200 PLANTATION, FL 33324 CONTACT: ASHLEY RESTA PHONE: (954) 519-1483		<ul style="list-style-type: none"> PROVIDE AND INSTALL ALL STORM SEWER LINES AND ASSOCIATED APPURTENANCES PER THE PLANS AND SPECIFICATION REFER TO GRADING PLAN FOR INFORMATION ON ALLOWABLE STORM SEWER MATERIALS 		ENERGY MANAGEMENT DEPT. (479) 204-0452

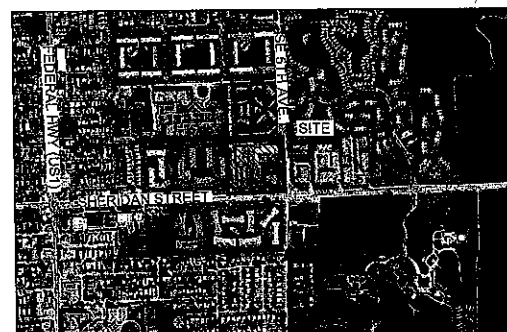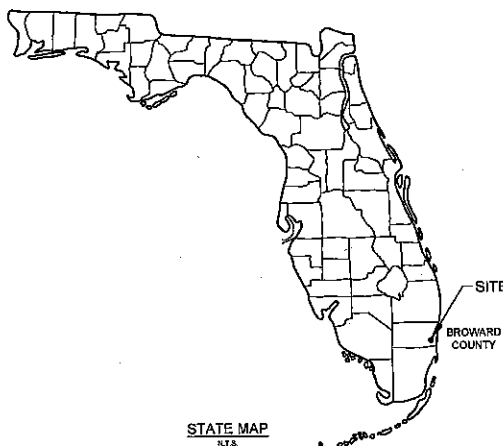

Sheet Number	Sheet Title
6010	COVER SHEET
6011	ALTA SURVEY
6115	SOIL MANAGEMENT PLAN
6150	ESCP NOTES
6151	ESCP SEQUENCE AND LIMITS OF WORK
6152	ESCP PHASE I SITE MAP
6153	ESCP PHASE II SITE MAP
6154	ESCP DETAILS
6155	ESCP DETAILS
6158	ESCP PERFORMANCE STANDARDS
6160	DEWATERING PLAN
6200	DEMOLITION PLAN
6220	SITE PLAN
6221	VEHICLE CIRCULATION, SIGNING AND MARKING PLAN
6250	GRADING AND DRAINAGE PLAN
6260	UTILITY PLAN
6310	SITE DETAILS
6320	GRADING AND DRAINAGE DETAILS
6321	GRADING AND DRAINAGE DETAILS
6340	UTILITY DETAILS
6341	UTILITY DETAILS
6342	FIRE UTILITY DETAILS
6500	LANDSCAPE PLAN
6510	LANDSCAPE DETAILS

PROJECT DESIGN TEAM

- CIVIL**
CHRISTOPHER J. HOLLEN, P.E.
KIMLEY-HORN AND ASSOCIATES, INC.
449 20TH STREET, SUITE 200
VERO BEACH, FLORIDA 32960
PHONE: (772) 794-4100
- GEOTECHNICAL ENGINEER**
JOSE GOMEZ, P.E.
ECS - FLORIDA, LLC
2000 AVENUE P, SUITE 3
WEST PALM BEACH, FL 33404
PHONE: (561) 846-3067
- SURVEY**
JOHN T. DODDAN
AVIROM & ASSOCIATES, INC.
50 SW 2ND AVENUE
BOCA RATON, FL 33432
PHONE: (561) 356-2594
- ENVIRONMENTAL**
LUKE DAVIS
KIMLEY-HORN AND ASSOCIATES, INC.
12740 GRAN BAY PARKWAY WEST
SUITE 2350
JACKSONVILLE, FL 32258
- LANDSCAPE ARCHITECT**
DAVID SIMS, RLA
KIMLEY-HORN AND ASSOCIATES, INC.
405 5TH STREET, SUITE 200
VERO BEACH, FLORIDA 32960
PHONE: (772) 794-4100
- BUILDING ARCH.**
PABLO BALAZAR
CUNHA & PETERSON ARCHITECTS
1925 PROSPECT AVE.
ORLANDO, FL 32814
407-661-9100

OWNER/ LESSOR :
DDRM SHERIDAN SQUARE, LLC
 401 E. SHERIDAN ST.
 DANIA BEACH, FL 33004

ALERT TO CONTRACTOR
 1. THE SITEWORK FOR THE WALMART PORTION OF THIS PROJECT SHALL MEET OR EXCEED THE "SITE SPECIFIC SPECIFICATIONS."
 2. ALL NECESSARY INSPECTIONS AND/OR CERTIFICATIONS REQUIRED BY CODES AND/OR UTILITY SERVICES COMPANIES SHALL BE PERFORMED PRIOR TO CONTRACT COMPLETION AND THE FINAL CONNECTION OF SERVICES.

DEVELOPER/ LESSEE :
WAL-MART STORES EAST, LP
 2001 S.E. 10th STREET, SWDC
 BENTONVILLE, AR 72716-0550
 PHONE: (479) 273-4000

ADDITIONAL GOVERNING AGENCY CONTACTS:

- CITY ENGINEERING**
CITY OF DANIA BEACH
PUBLIC SERVICES DEPARTMENT
100 W. DANIA BEACH BLVD.
DANIA BEACH, FL 33004
(954) 924-6500
- BUILDING OFFICIAL**
CITY OF DANIA BEACH
BUILDING DEPARTMENT - CITY OFFICIAL
100 W. DANIA BEACH BLVD.
DANIA BEACH, FL 33004
(954) 924-6500
CONTACT: JACK FISHER
- CITY PLANNING/ZONING**
CITY OF DANIA BEACH
PLANNING AND ZONING DEPARTMENT
100 W. DANIA BEACH BLVD.
DANIA BEACH, FL 33004
(954) 924-6800
CONTACT: MARK LAFERRIER
- FIRE CHIEF**
BROWARD COUNTY FIRE DEPT. - STATION 1
116 W. DANIA BEACH BLVD
DANIA BEACH, FL 33004
(954) 924-6915
CONTACT: MICHAEL CASSANO
- STORMWATER**
BROWARD COUNTY EPD
1 N. UNIVERSITY DRIVE
PLANTATION, FL 33301
PHONE: (954) 519-1243
CONTACT: ASHLEY RESTA
- PUBLIC WORKS**
CITY OF DANIA BEACH
PUBLIC SERVICES DEPARTMENT
100 W. DANIA BEACH BLVD.
DANIA BEACH, FL 33004
(954) 924-3740
CONTACT: DOMINIC ORLANDO, P.E.
- TRANSPORTATION - FDOT**
DISTRICT 4
3400 WEST COMMERCIAL BLVD
FT. LAUDERDALE, FL 33309
(954) 771-4377
CONTACT: STAN WILLIAMS

WORK HOURS:
 THE OPERATING OF ANY EQUIPMENT USED IN CONSTRUCTION WITHIN 50 METERS OF ANY RESIDENTIAL AREA BETWEEN THE HOURS OF 9 P.M. AND 7 A.M. ON WEEKDAYS AND SATURDAY, AND 9 P.M. TO 6 A.M. ON SUNDAY AND HOLIDAYS EXCEPT FOR EMERGENCY WORK - CITY CODE, ARTICLE IV - SECTION 17.66.

THIS MATRIX HAS BEEN PROVIDED FOR INFORMATIONAL PURPOSES. THE CONTRACTOR SHALL PROVIDE ANY AND ALL APPURTENANCES, TRENCHING AND BACKFILL, AND OTHER INCIDENTALS TO MEET OR EXCEED THE SPECIFICATIONS OF THE ITEMS LISTED.

MEDIAN AGE: 42

ENGINEER:
KIMLEY-HORN AND ASSOCIATES, INC.
 445 24TH STREET, SUITE 200
 VERO BEACH, FLORIDA 32960
 PHONE: (772) 794-4100

DESIGN BY
 CHRISTOPHER J. HOLLEN, P.E.
 FL LICENSE NUMBER
 74685
 DATE:

SCALE AS NOTED
 DESIGNED BY
 DRAWN BY
 CHECKED BY
 C/JH

COVER SHEET

Walmart STORE #4563-00
 DANIA BEACH, FL
 WAL-MART STORES EAST, LP
 DANIA BEACH


DATE
 10/22/14
 PROJECT NO.
 147253678
 SHEET NUMBER
 6010

10/22/14 10:58 AM C:\Users\johnd\Documents\4563-00\4563-00.dwg Plot: 10/22/14 10:58 AM 147253678.dwg 147253678.dwg 147253678.dwg

ALTA / ACSM LAND TITLE SURVEY

SYMBOL LEGEND:

- BACKFLOW PREVENTOR VALVE
- BOLLARD
- CATCH BASIN
- DISABLED PARKING SPACE
- DOUBLE DETECTOR CHECK VALVE
- ELECTRIC SERVICE BOX
- FIRE HYDRANT
- GREASE TRAP
- GUY ANCHOR
- IRRIGATION CONTROL BOX
- IRRIGATION CONTROL VALVE
- METAL LIGHT POLE
- MONITORING WELL
- OVERHEAD WIRES
- ROOF DRAIN
- SANITARY CLEANOUT
- SANITARY MANHOLE
- SANITARY VALVE
- SIGN
- STANDARD PARKING SPACE
- WATER METER
- WATER VALVE
- WOOD LIGHT POLE
- WOOD UTILITY POLE
- YARD DRAIN
- UNDERGROUND ELECTRIC LINE
- UNDERGROUND DRAINAGE LINE
- UNDERGROUND GAS LINE
- UNDERGROUND SANITARY LINE
- UNDERGROUND UNKNOWN LINE
- UNDERGROUND WATER LINE
- NON-VEHICULAR ACCESS LINE (P.B. 117/2, B.C.R.)
- NON-VEHICULAR ACCESS LINE (P.B. 117, PG. 2, B.C.R.)
- 2.00
- 2.0

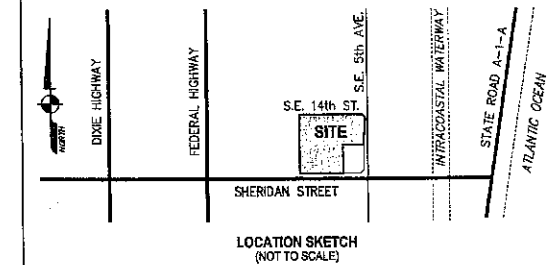

SUMMARY TABLE FOR:
SCHEDULE B - SECTION 2 EXCEPTIONS
TITLE COMMITMENT NO. 20140309 (SEE SURVEYOR'S REPORT #2)

EXCEPTION NUMBER AND RECORDING INFORMATION	AFFECTS SUBJECT PROPERTY	AFFECTED AREA
No. 5 P.B. 117/2	Yes	As shown
No. 7 O.R.B. 18712/137	Yes	Access Easement (as shown)
No. 8 O.R.B. 18712/178	Yes	Resolution of Access Easement
No. 9 O.R.B. 18712/191	Yes	Agreement (not platable)
No. 10 O.R.B. 18712/193	Yes	F.F. Easement (as shown)
No. 11 O.R.B. 32225/1720	Yes	Telephone Space Lease (not platable)
No. 12 O.R.B. 31355/440	No	Vacated Easement (rest of property line)
No. 13 O.R.B. 34165/1891	Yes	Wellness Ordinance (not platable)
No. 15 O.R.B.	Yes	As shown
No. 16 O.R.B. 44267/1802	Yes	Mortgage (not platable)
O.R.B. 44718/1808	Yes	Mortgage (not platable)
O.R.B. 46722/953	Yes	Mortgage (not platable)
No. 18 O.R.B. 46225/1	Yes	Financing Statement (not platable)
O.R.B. 44718/1876	Yes	Financing Statement (not platable)
O.R.B. 46722/956	Yes	Amendment (not platable)
O.R.B. 46722/521	Yes	Amendment (not platable)

EXISTING PARKING DATA:

EXISTING SPACES:	335
DISABLED SPACES:	10
TOTAL SPACES:	345

SURVEYOR'S REPORT:

- Reproductions of this Sketch are not valid without the signature and the original raised seal of a Florida licensed surveyor and mapper.
- The property shown hereon is subject to agreements, covenants, easements, restrictions and other matters contained in the Title Commitment issued by Stewart Title Guaranty Company (Chicago), Title Commitment No. 20140309, effective date November 11, 2014 at 8:00 AM, as prepared by Francine Whalum and Stephanie Natolina. Where applicable, these instruments are shown on the survey (see SUMMARY TABLE). Aviom & Associates, Inc. did not research the public records for easements, rights-of-way, ownership or other instruments of record.
- The land description shown hereon is in accord with the Title Commitment.
- The underground utilities shown have been located from aboveground point markings found during the field survey as marked by other agents. The surveyor makes no guarantee that the underground utilities shown comprise all such utilities in the area, either in service or abandoned. The surveyor further does not warrant that the underground utilities shown are in the exact location indicated although he does certify that they are located accurately as possible from information available. The surveyor has not physically located the underground utilities.
- Elevations indicated hereon are in feet and decimals referenced to the North American Vertical Datum of 1988 (NAVD 88).
- Benchmark Description: Broward County Engineering Division No. 1894, Found Brass Disc Stamped "X234 1955", Elevation 13.038 (NGVD 29), Elevation 11.438 (NAVD 88).
- Bearings shown hereon are relative to the plot, based on the south line of Tract "A", having a bearing of N 88°37'24" E.
- The entire property described hereon lies within Flood Zones X and AE (EL 5), as shown on the Federal Emergency Management Agency (FEMA) Flood Insurance Rate Map, Community Panel No. 120034 0567 H, dated August 18, 2014 (North American Vertical Datum of 1988).
- Symbols shown hereon and in the legend may have been enlarged for clarity. These symbols have been plotted at the center of the field location and may not represent the actual shape or size of the feature.
- This map is intended to be displayed at a scale of 1"=40'.
- Units of measurement are in U.S. Survey Feet and decimal parts thereof. Well identified features in this survey were field measured to a horizontal positional accuracy of 0.10'.
- Site Address: 401 E. Sheridan Street, Dania Beach, FL 33004
- Adjacent property owner information shown hereon was obtained from the Broward County Property Appraiser's website.
- Abbreviation Legend: ACSM = American Congress on Surveying and Mapping; ALTA = American Land Title Association; B.C.R. = Broward County Records; C = Calculated; CB = Catch Basin; C = Centerline; CONC = Concrete; EL = Elevation; F.B. = Field Book; FD = Found; F.F. = Finished Floor; F.P.L. = Florida Power and Light Company; ID = Identification; I.P. = Iron Pipe; I.R. = Iron Rod; L.B. = Licensed Business; Ms = Measured; NSPS = National Society of Professional Surveyors; O.R.B. = Official Records Book; OW = Overhead Wires; P = Per Record Plat; P.B. = Plat Book; PG. = Page; P.L.S. = Professional Land Surveyor; P.O.B. = Point of Beginning; P.O.C. = Point of Commencement; R/W = Right-of-Way; W/CAP = With Surveyors Cap; YD = Yard Drain; SMH = Sanitary Manhole

LAND DESCRIPTION:

PARCEL 1:
TRACT A, SANDPIPER BAY COMMERCIAL, according to the plat thereof recorded in Plat Book 117, Page 2, Public Records of Broward County, Florida, LESS that portion described as follows:
COMMENCE at the Southwest corner of said Tract A; thence on an assumed bearing of North 88 degrees 37 minutes 24 seconds East along the South boundary of said Tract A, a distance of 418.36 feet to the Point of Beginning; thence North 01 degrees 37 minutes 09 seconds West a distance of 265.00 feet; thence North 88 degrees 37 minutes 24 seconds East a distance of 200.00 feet to the intersection with the said Easterly boundary of Tract A; thence South 01 degrees 37 minutes 09 seconds East along said Easterly boundary a distance of 229.85 feet to an angle point on the boundary of Tract A; thence South 43 degrees 30 minutes 07.5 seconds West and along said boundary a distance of 49.60 feet to the South boundary of Tract A; thence South 88 degrees 37 minutes 24 seconds West along said South boundary a distance of 164.85 feet to the POINT OF BEGINNING.

ALSO DESCRIBED AS:
TRACT A of SANDPIPER BAY COMMERCIAL, according to the plat thereof recorded in Plat Book 117, Page 2, Public Records of Broward County, Florida, LESS that portion described as TRANSFLORIDAS BANK OFFICE BUILDING, a Condominium, according to the Declaration thereof, recorded in Official Records Book 13221, Page 342, Public Records of Broward County, Florida.


Said lands lying and situate in the City of Dania Beach, Broward County, Florida, containing 287,059 square feet (6.5900 acres), more or less.

CERTIFICATION:

THIS IS TO CERTIFY that this map or plat and the survey on which it is based were made in accordance with the 2011 Minimum Standard Detail Requirements for ALTA/ACSM Land Title Surveys, jointly established and adopted by ALTA and NSPS. The field work was completed on November 26, 2014.

Date of Plat or Map: 11/20/2015

 JOHN T. DOOGAN, P.L.S.
 Florida Registration No. 4409
 AVIOM & ASSOCIATES, INC.
 L.B. No. 3300
 EMAIL: john@aviomsurvey.com

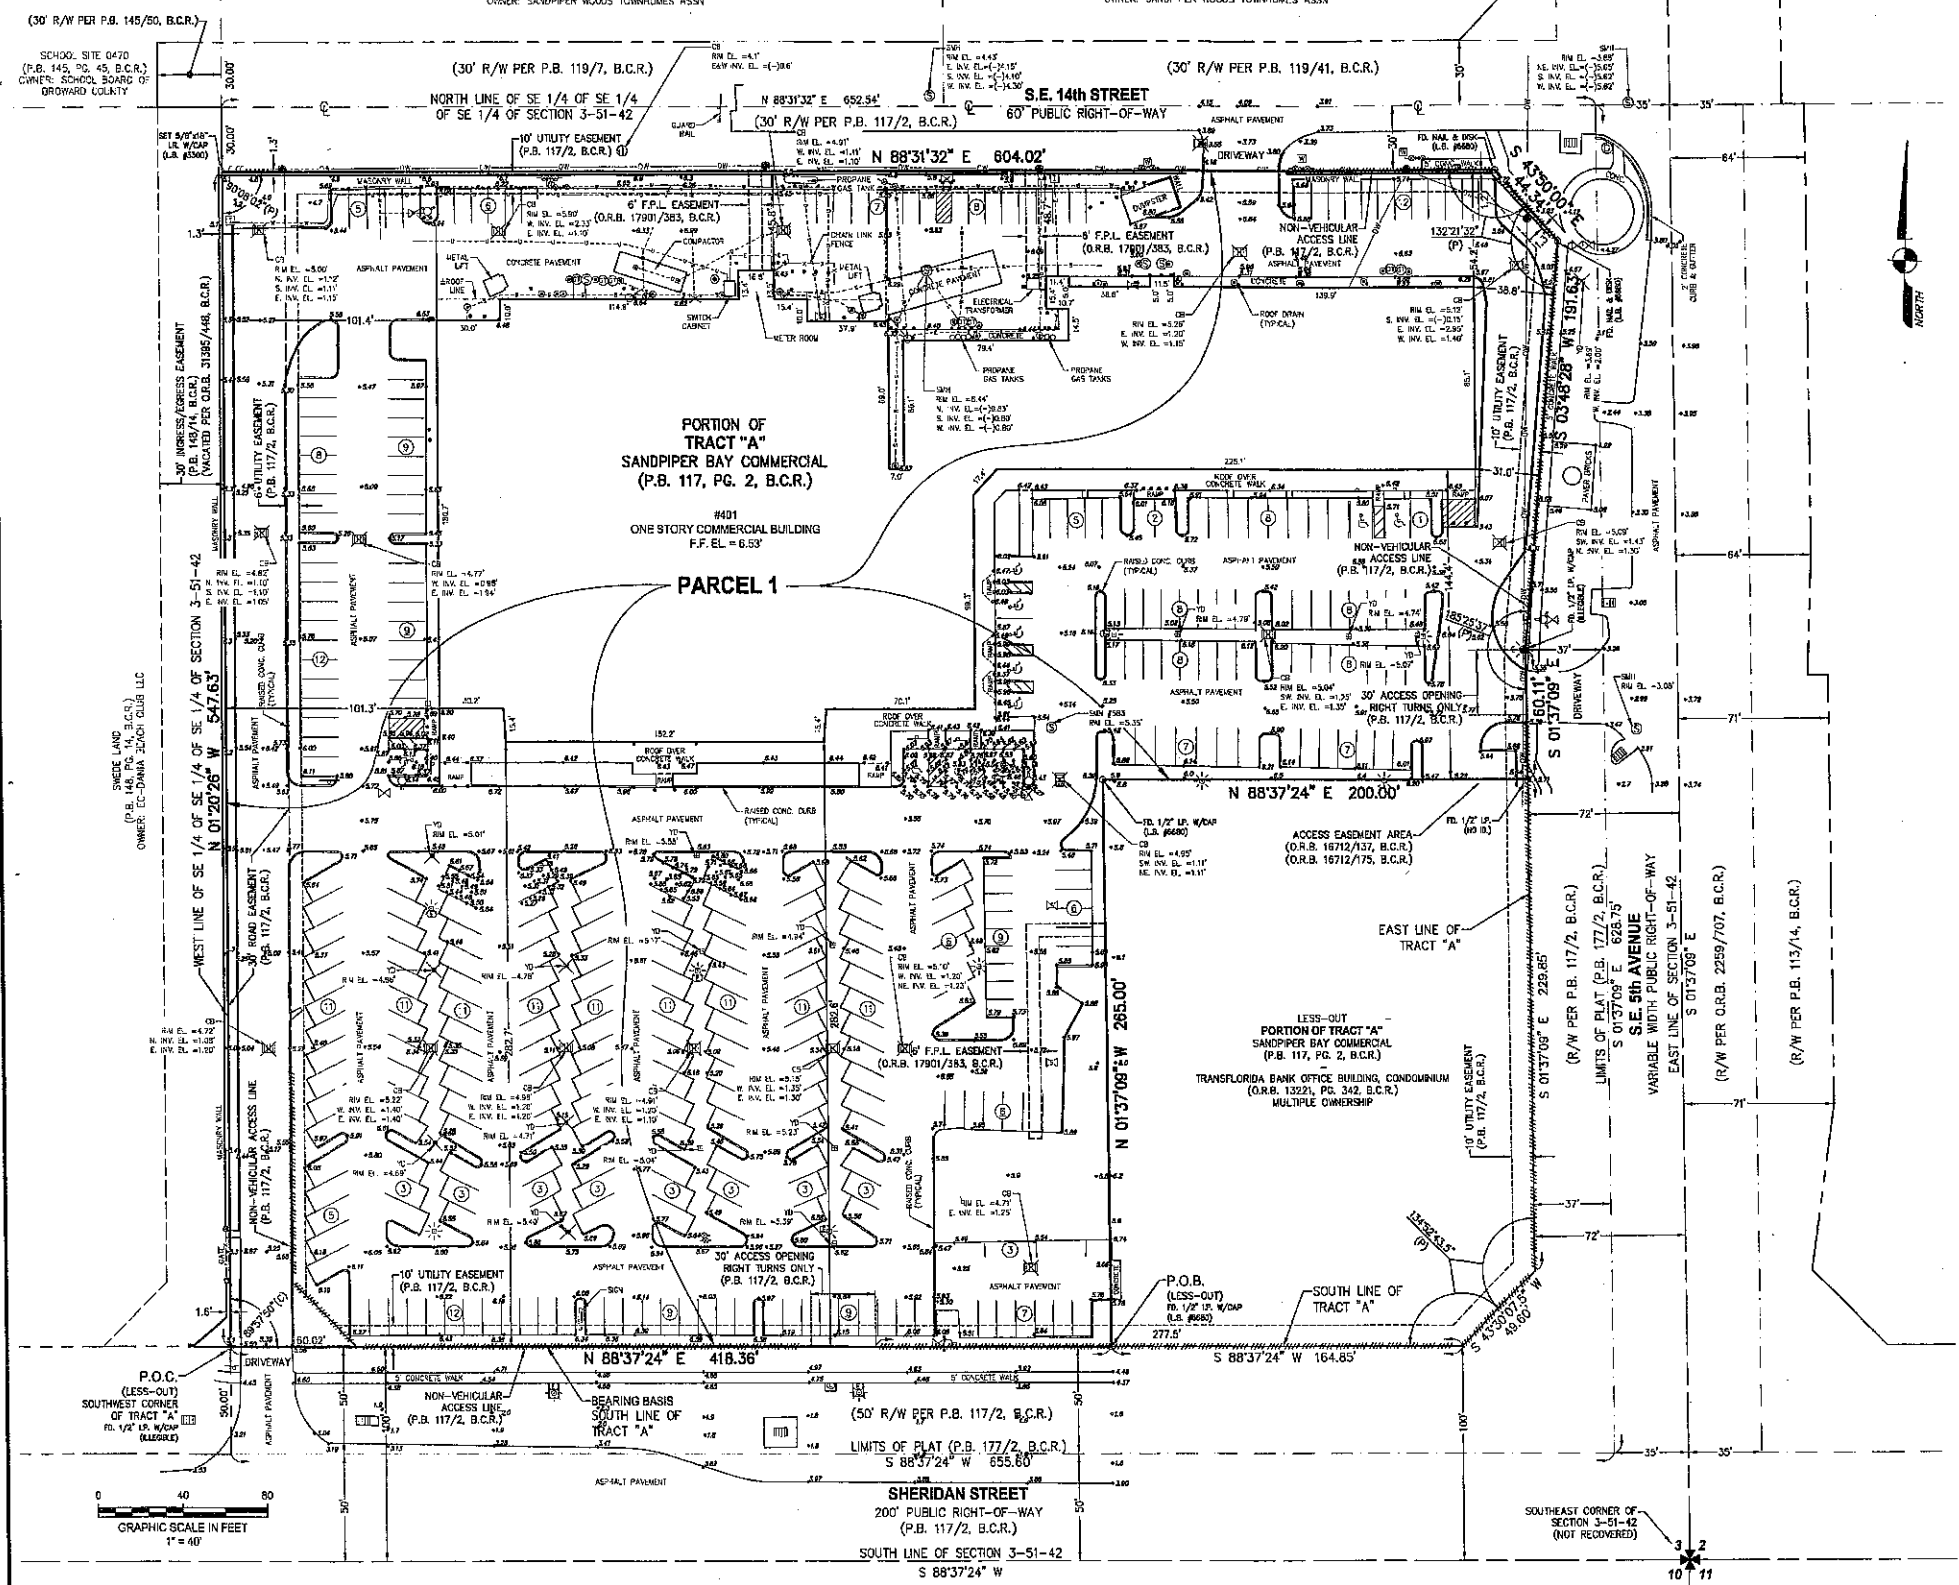


AVIOM & ASSOCIATES, INC.
SURVEYING & MAPPING
 50 S.W. 2ND AVENUE, SUITE 102, BOCA RATON, FLORIDA 33432
 TEL. (561) 392-2594, FAX (561) 394-7125
 www.AVIOM-SURVEY.com
 © 2014 AVIOM & ASSOCIATES, INC. All rights reserved. This sketch is the property of AVIOM & ASSOCIATES, INC. and should not be reproduced or copied without written permission.


REVISIONS	DATE	F.B./PG.	BY	CKD	REVISIONS	DATE	F.B./PG.	BY	CKD
ADD TOP AND PERMITS	3/23/2015	109/11 & 113/2	JD	ATD					

ALTA / ACSM LAND TITLE SURVEY
A PORTION OF TRACT "A"
 SANDPIPER BAY COMMERCIAL
 (P.B. 117, PG. 2, B.C.R.)
 SECTION 3, TOWNSHIP 51 SOUTH, RANGE 42 EAST
 DANIA BEACH, FLORIDA
 BROWARD COUNTY, FLORIDA


JOB #: 9786
 SCALE: 1" = 40'
 DATE: 11/26/2014
 BY: S.A.M.
 CHECKED: J.T.D.
 F.B. 1680 PG. 69-75
 SHEET 1 OF 1

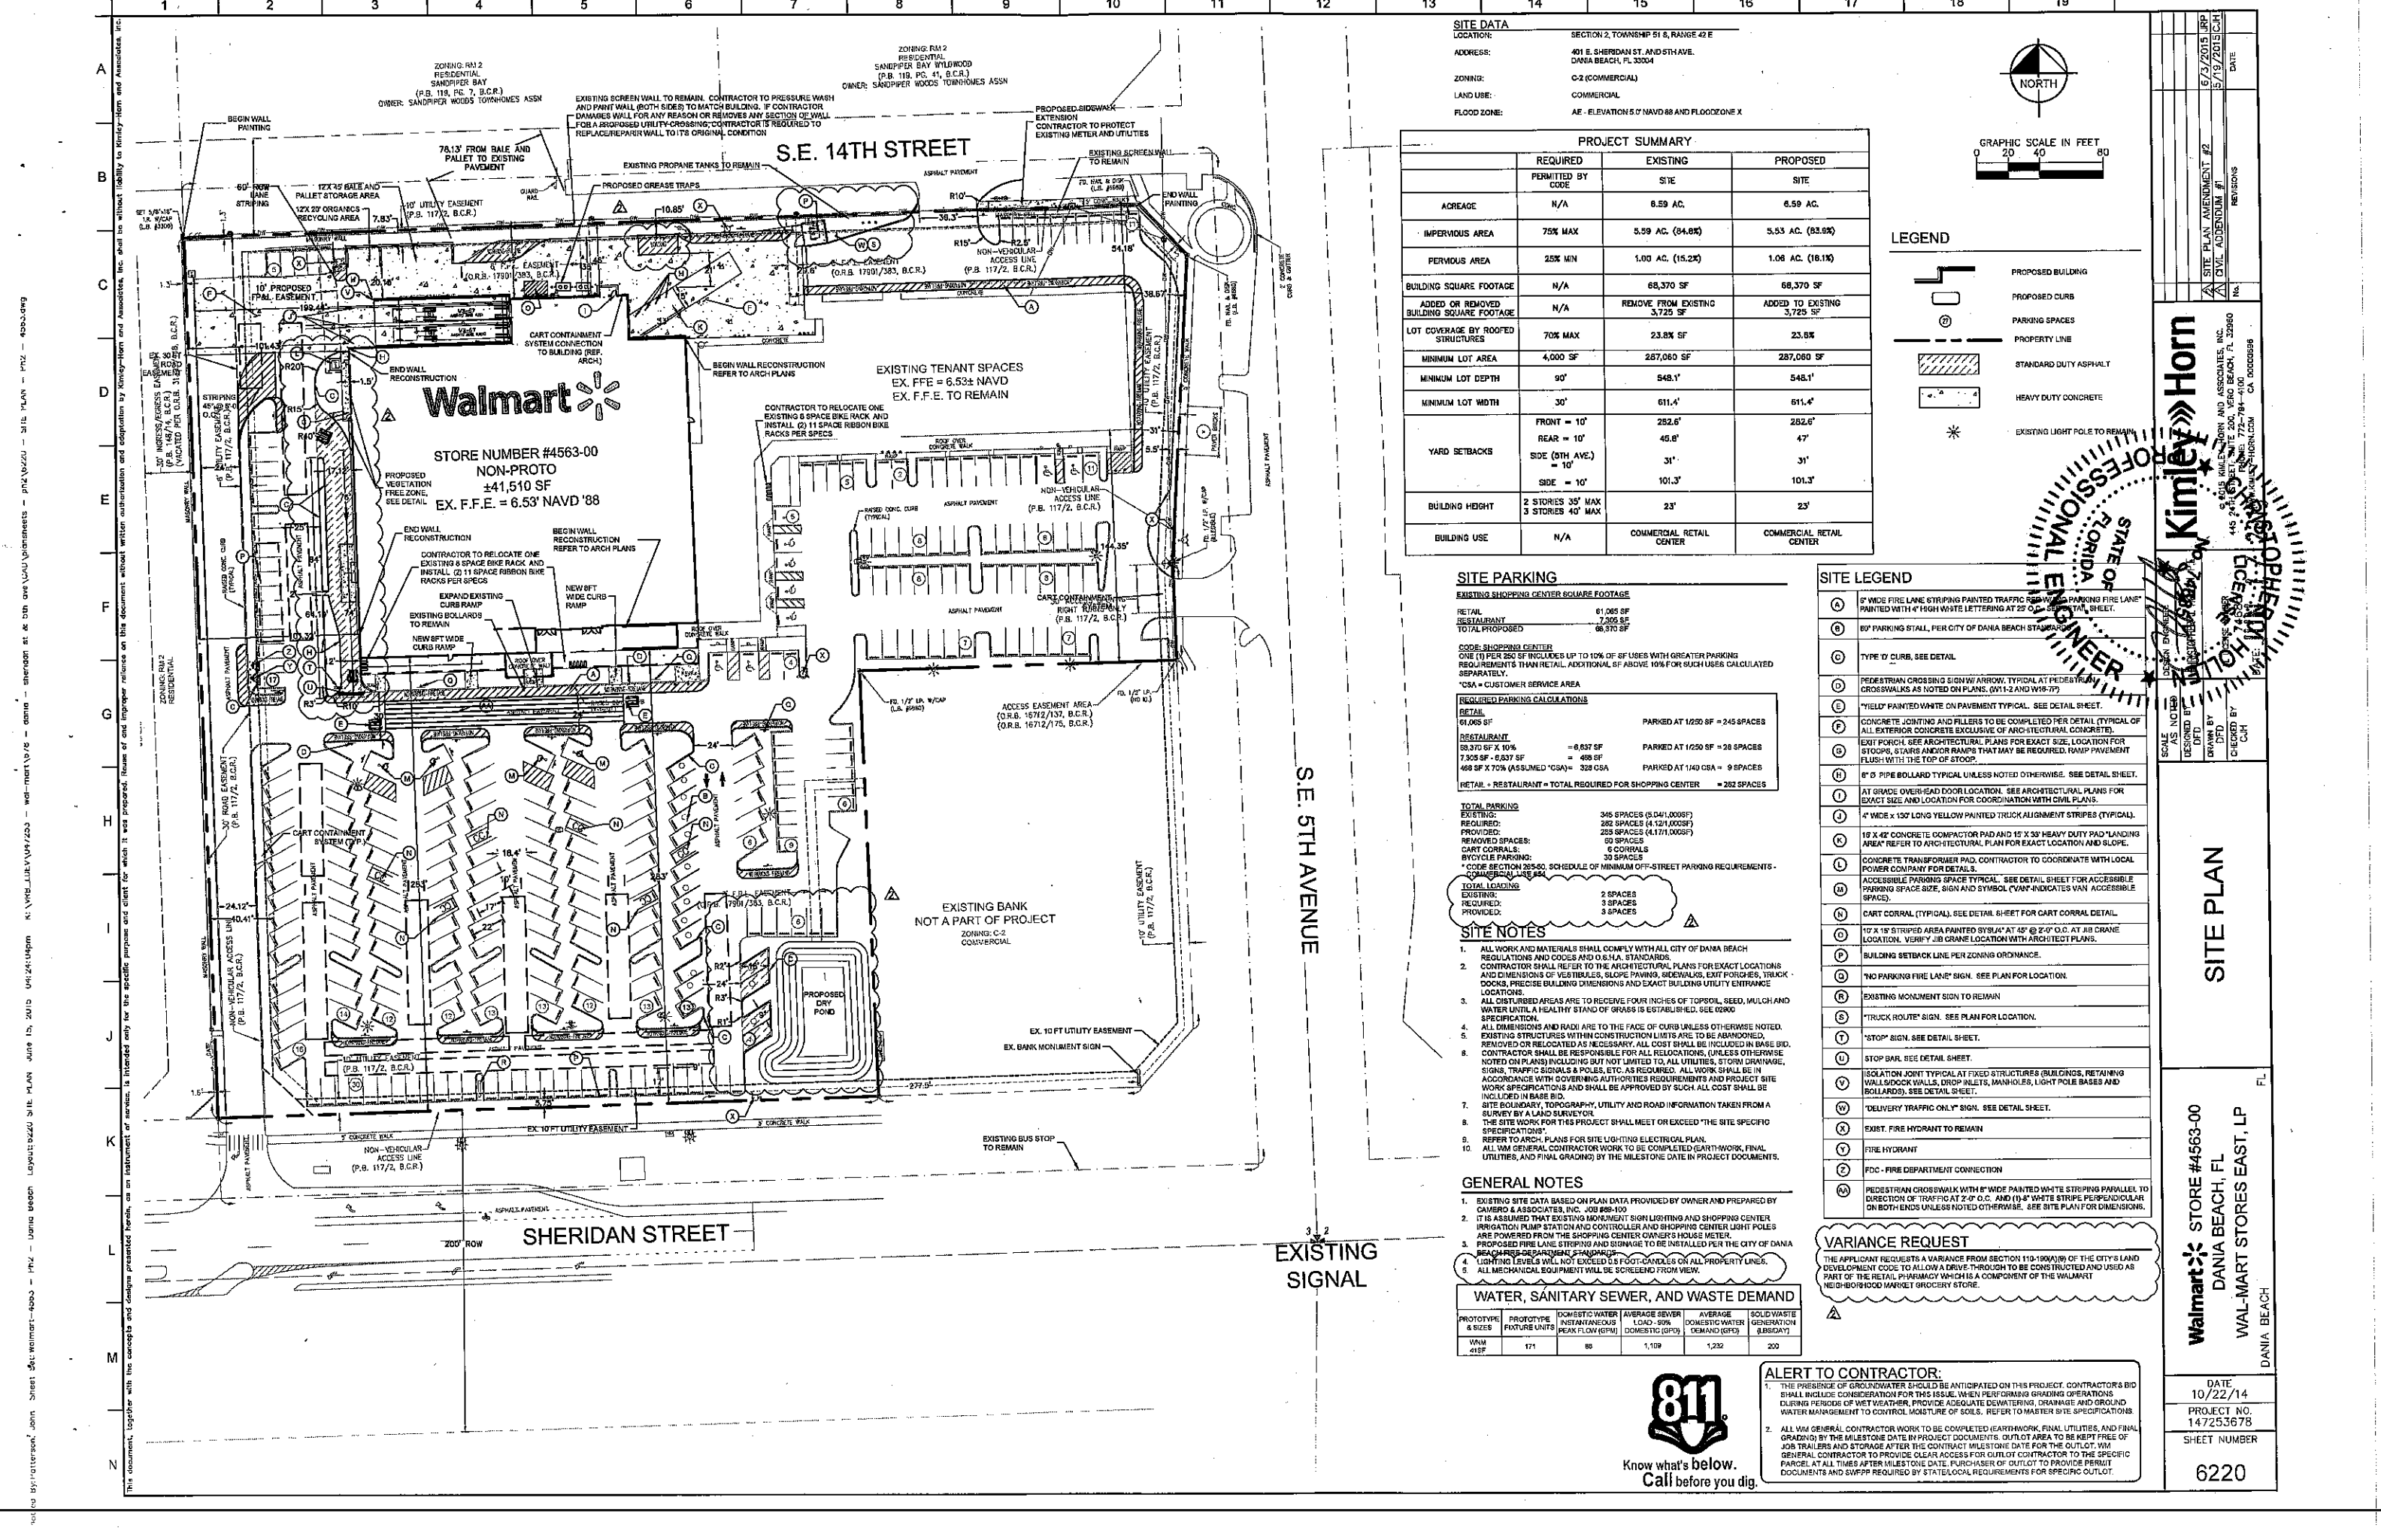

SITE DATA
 LOCATION: SECTION 2, TOWNSHIP 51 S, RANGE 42 E
 ADDRESS: 401 E. SHERIDAN ST. AND 5TH AVE. DANIA BEACH, FL 33004
 ZONING: C-2 (COMMERCIAL)
 LAND USE: COMMERCIAL
 FLOOD ZONE: AE - ELEVATION 5.0' NAVD 88 AND FLOODZONE X

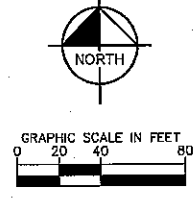

PROJECT SUMMARY			
	REQUIRED PERMITTED BY CODE	EXISTING SITE	PROPOSED SITE
ACREAGE	N/A	8.59 AC. (84.8%)	6.59 AC. (65.9%)
IMPERVIOUS AREA	75% MAX	5.99 AC. (84.8%)	5.53 AC. (85.5%)
PERVIOUS AREA	25% MIN	1.00 AC. (15.2%)	1.08 AC. (16.1%)
BUILDING SQUARE FOOTAGE	N/A	68,370 SF	68,370 SF
ADDED OR REMOVED BUILDING SQUARE FOOTAGE	N/A	REMOVE FROM EXISTING 3,725 SF	ADDED TO EXISTING 3,725 SF
LOT COVERAGE BY ROOFED STRUCTURES	70% MAX	23.8% SF	23.5%
MINIMUM LOT AREA	4,000 SF	287,080 SF	287,080 SF
MINIMUM LOT DEPTH	90'	548.1'	548.1'
MINIMUM LOT WIDTH	30'	611.4'	611.4'
YARD SETBACKS			
	FRONT = 10'	282.6'	282.6'
	REAR = 10'	45.8'	47'
	SIDE (5TH AVE.) = 10'	31'	31'
	SIDE = 10'	101.3'	101.3'
BUILDING HEIGHT	2 STORIES 35' MAX 3 STORIES 40' MAX	23'	23'
BUILDING USE	N/A	COMMERCIAL RETAIL CENTER	COMMERCIAL RETAIL CENTER

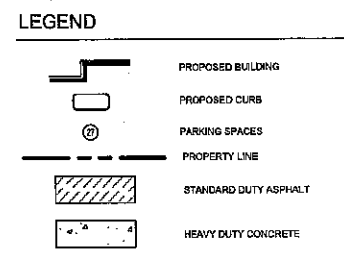

SITE PARKING

EXISTING SHOPPING CENTER SQUARE FOOTAGE

RETAIL	61,065 SF	
RESTAURANT	7,305 SF	
TOTAL PROPOSED	68,370 SF	

REQUIRED SHOPPING CENTER

ONE (1) PER 500 SF INCLUDES UP TO 10% OF SF USES WITH GREATER PARKING REQUIREMENTS THAN RETAIL. ADDITIONAL SF ABOVE 10% FOR SUCH USES CALCULATED SEPARATELY.

*CSA = CUSTOMER SERVICE AREA

RETAIL	61,065 SF	PARKED AT 1/250 SF = 245 SPACES
RESTAURANT	7,305 SF X 10% = 730 SF	PARKED AT 1/250 SF = 28 SPACES
468 SF X 70% (ASSUMED *CSA)	328 CSA	PARKED AT 1/400 CSA = 9 SPACES
RETAIL + RESTAURANT = TOTAL REQUIRED FOR SHOPPING CENTER		= 282 SPACES

TOTAL PARKING

EXISTING	345 SPACES (0.041/000SF)
REQUIRED	282 SPACES (4.12/1000SF)
PROVIDED	282 SPACES (4.12/1000SF)
REMOVED SPACES:	50 SPACES
CART CORRAL:	6 CORRALS
BIKEWAY PARKING:	30 SPACES
* CODE SECTION 255.00, SCHEDULE OF MINIMUM OFF-STREET PARKING REQUIREMENTS - COMMERCIAL USE 84	

TOTAL LOADINGS

EXISTING	2 SPACES
REQUIRED	3 SPACES
PROVIDED:	3 SPACES

- SITE LEGEND**
- (A) 6" WIDE FIRE LANE STRIPING PAINTED TRAFFIC RED WITH PARKING FIRE LANE PAINTED WITH 4" HIGH WHITE LETTERING AT 22' O.C.
 - (B) 60" PARKING STALL, PER CITY OF DANIA BEACH STANDARD
 - (C) TYPE 'D' CURB, SEE DETAIL
 - (D) PEDESTRIAN CROSSING SIGN WITH ARROW, TYPICAL AT PEDESTRIAN CROSSWALKS AS NOTED ON PLANS. (W11-2 AND W18-7P)
 - (E) 'YIELD' PAINTED WHITE ON PAVEMENT TYPICAL. SEE DETAIL SHEET.
 - (F) CONCRETE JOINTS AND FILLERS TO BE COMPLETED PER DETAIL TYPICAL OF ALL EXTERIOR CONCRETE EXCLUSIVE OF ARCHITECTURAL CONCRETE.
 - (G) EXIT PORCH. SEE ARCHITECTURAL PLANS FOR EXACT SIZE, LOCATION FOR STOPS, STAIRS AND/OR RAMP THAT MAY BE REQUIRED. RAMP PAVEMENT FLUSH WITH THE TOP OF STOOP.
 - (H) 8" Ø PIPE BOLLARD TYPICAL UNLESS NOTED OTHERWISE. SEE DETAIL SHEET.
 - (I) AT GRADE OVERHEAD DOOR LOCATION. SEE ARCHITECTURAL PLANS FOR EXACT SIZE AND LOCATION FOR COORDINATION WITH CIVIL PLANS.
 - (J) 4" WIDE x 150' LONG YELLOW PAINTED TRUCK ALIGNMENT STRIPES (TYPICAL)
 - (K) 18" X 42" CONCRETE COMPACTOR PAD AND 12" X 33" HEAVY DUTY PAD 'LANDING AREA' REFER TO ARCHITECTURAL PLAN FOR EXACT LOCATION AND LOCAL.
 - (L) CONCRETE TRANSFORMATION PAD. CONTRACTOR TO COORDINATE WITH LOCAL POWER COMPANY FOR DETAILS.
 - (M) ACCESSIBLE PARKING SPACE TYPICAL. SEE DETAIL SHEET FOR ACCESSIBLE PARKING SPACE SIZE, SIGN AND SYMBOL. 'VAN' INDICATES VAN ACCESSIBLE SPACE.
 - (N) CART CORRAL (TYPICAL). SEE DETAIL SHEET FOR CART CORRAL DETAIL.
 - (O) 10' X 15' STRIPED AREA PAINTED YELLOW AT 45° AT 2'-0" O.C. AT JIB CRANE LOCATION. VERIFY JIB CRANE LOCATION WITH ARCHITECT PLANS.
 - (P) BUILDING SETBACK LINE PER ZONING ORDINANCE.
 - (Q) 'NO PARKING FIRE LANE' SIGN. SEE PLAN FOR LOCATION.
 - (R) EXISTING MONUMENT SIGN TO REMAIN
 - (S) 'TRUCK ROUTE' SIGN. SEE PLAN FOR LOCATION.
 - (T) 'STOP' SIGN. SEE DETAIL SHEET.
 - (U) STOP BAR. SEE DETAIL SHEET.
 - (V) ISOLATION JOINT TYPICAL AT FIXED STRUCTURES (BUILDINGS, RETAINING WALLS, DOCK WALLS, DROP INLETS, MANHOLES, LIGHT POLE BASES AND BOLLARDS). SEE DETAIL SHEET.
 - (W) 'DELIVERY TRAFFIC ONLY' SIGN. SEE DETAIL SHEET.
 - (X) EXIST. FIRE HYDRANT TO REMAIN
 - (Y) FIRE HYDRANT
 - (Z) FDC - FIRE DEPARTMENT CONNECTION
 - (AA) PEDESTRIAN CROSSWALK WITH 6" WIDE PAINTED WHITE STRIPING PARALLEL TO DIRECTION OF TRAFFIC AT 2'-0" O.C. AND 10" WIDE STRIPE PERPENDICULAR ON BOTH ENDS UNLESS NOTED OTHERWISE. SEE SITE PLAN FOR DIMENSIONS.

- SITE NOTES**
- ALL WORK AND MATERIALS SHALL COMPLY WITH ALL CITY OF DANIA BEACH REGULATIONS AND ORDINANCES AND D.B.A. STANDARDS.
 - CONTRACTOR SHALL REFER TO THE ARCHITECTURAL PLANS FOR EXACT LOCATIONS AND DIMENSIONS OF VESTIBULES, SIDEWALKS, EXIT PORCHES, TRUCK DOCKS, PRECISE BUILDING DIMENSIONS AND EXACT BUILDING UTILITY ENTRANCE LOCATIONS.
 - ALL DISTURBED AREAS ARE TO RECEIVE FOUR INCHES OF TOPSOIL, SEED, MULCH AND WATER UNTIL A HEALTHY STAND OF GRASS IS ESTABLISHED. SEE 02800 SPECIFICATION.
 - ALL DIMENSIONS AND RADII ARE TO THE FACE OF CURB UNLESS OTHERWISE NOTED. EXISTING STRUCTURES WITHIN CONSTRUCTION LIMITS ARE TO BE ABANDONED, REMOVED OR RELOCATED AS NECESSARY. ALL COST SHALL BE INCLUDED IN BASE BID. CONTRACTOR SHALL BE RESPONSIBLE FOR ALL RELOCATIONS, UNLESS OTHERWISE NOTED ON PLANS INCLUDING BUT NOT LIMITED TO: ALL UTILITIES, STORM DRAINAGE, SIGNS, TRAFFIC SIGNALS & POLES, ETC. AS REQUIRED. ALL WORK SHALL BE IN ACCORDANCE WITH GOVERNING AUTHORITIES REQUIREMENTS AND PROJECT SITE WORK SPECIFICATIONS AND SHALL BE APPROVED BY SUCH. ALL COST SHALL BE INCLUDED IN BASE BID.
 - THE SITE WORK FOR THIS PROJECT SHALL MEET OR EXCEED "THE SITE SPECIFIC SPECIFICATIONS".
 - REFER TO ARCH. PLANS FOR SITE LIGHTING ELECTRICAL PLAN.
 - ALL GENERAL CONTRACTOR WORK TO BE COMPLETED EARLY WORK, FINAL UTILITIES, AND FINAL GRADING) BY THE MILESTONE DATE IN PROJECT DOCUMENTS.

- GENERAL NOTES**
- EXISTING SITE DATA BASED ON PLAN DATA PROVIDED BY OWNER AND PREPARED BY CAMERO & ASSOCIATES, INC. JOB 858-110
 - IT IS ASSUMED THAT EXISTING MONUMENT SIGN LIGHTING AND SHOPPING CENTER IRRIGATION PUMP STATION AND CONTROLLER AND SHOPPING CENTER LIGHT POLES ARE POWERED FROM THE SHOPPING CENTER OWNER'S HOUSE METER.
 - PROPOSED FIRE LANE STRIPING AND SIGNAGE TO BE INSTALLED PER THE CITY OF DANIA BEACH FIRE DEPARTMENT STANDARDS.
 - LIGHTING LEVELS WILL NOT EXCEED 1.5 FOOT-CANDELES ON ALL PROPERTY LINES.
 - ALL MECHANICAL EQUIPMENT WILL BE SCREENED FROM VIEW.

WATER, SANITARY SEWER, AND WASTE DEMAND

PROTOTYPE & SIZES	PROTOTYPE FIXTURE UNITS	DOMESTIC WATER INSTANTANEOUS PEAK FLOW (GPM)	AVERAGE SEWER LOAD - 20% DOMESTIC (GPD)	AVERAGE DOMESTIC WATER DEMAND (GPD)	SOLID WASTE GENERATION (LBS/DAY)
W/M 419F	171	88	1,109	1,232	200

VARIANCE REQUEST

THE APPLICANT REQUESTS A VARIANCE FROM SECTION 110-190(A)(9) OF THE CITY'S LAND DEVELOPMENT CODE TO ALLOW A DRIVE-THROUGH TO BE CONSTRUCTED AND USED AS PART OF THE RETAIL PHARMACY WHICH IS A COMPONENT OF THE WALMART NEIGHBORHOOD MARKET GROCERY STORE.



ALERT TO CONTRACTOR:

- THE PRESENCE OF GROUNDWATER SHOULD BE ANTICIPATED ON THIS PROJECT. CONTRACTOR'S BID SHALL INCLUDE CONSIDERATION FOR THIS ISSUE. WHEN PERFORMING GRADING OPERATIONS DURING PERIODS OF WET WEATHER, PROVIDE ADEQUATE DEWATERING, DRAINAGE AND GROUND WATER MANAGEMENT TO CONTROL MOISTURE OF SOILS. REFER TO MASTER SITE SPECIFICATIONS.
- ALL GENERAL CONTRACTOR WORK TO BE COMPLETED EARLY WORK, FINAL UTILITIES, AND FINAL GRADING) BY THE MILESTONE DATE IN PROJECT DOCUMENTS. OUTLOT AREA TO BE KEPT FREE OF JOB TRAILERS AND STORAGE AFTER THE CONTRACT MILESTONE DATE FOR THE OUTLOT. GENERAL CONTRACTOR TO PROVIDE CLEAR ACCESS FOR OUTLOT CONTRACTOR TO THE SPECIFIC PARCEL AT ALL TIMES AFTER MILESTONE DATE. PURCHASER OF OUTLOT TO PROVIDE PERMIT DOCUMENTS AND SWPPP REQUIRED BY STATE/LOCAL REQUIREMENTS FOR SPECIFIC OUTLOT.



Kimley-Horn & Associates, Inc.
 STATE OF FLORIDA
 PROFESSIONAL ENGINEER
 LICENSE NO. 12578
 SCALE: NOTED
 DESIGNED BY: JLD
 DRAWN BY: DFD
 CHECKED BY: CCH

SITE PLAN

Walmart STORE #4563-00
 DANIA BEACH, FL
 WAL-MART STORES EAST, LP
 DANIA BEACH


DATE: 10/22/14
 PROJECT NO: 147253678
 SHEET NUMBER: 6220

This document, together with the concepts and designs presented herein, is intended only for the specific purpose and client for which it was prepared. Reuse of any part of this document without written authorization and approval by Kimley-Horn and Associates, Inc. shall be without liability to Kimley-Horn and Associates, Inc.

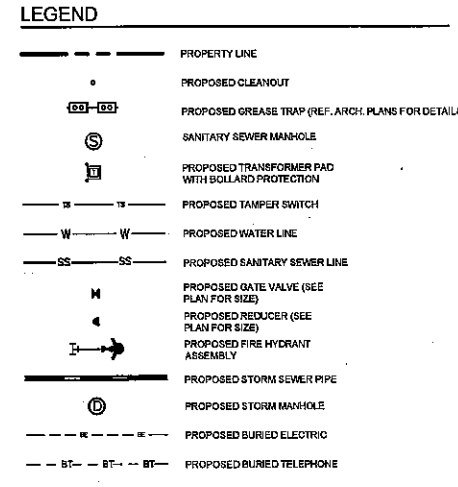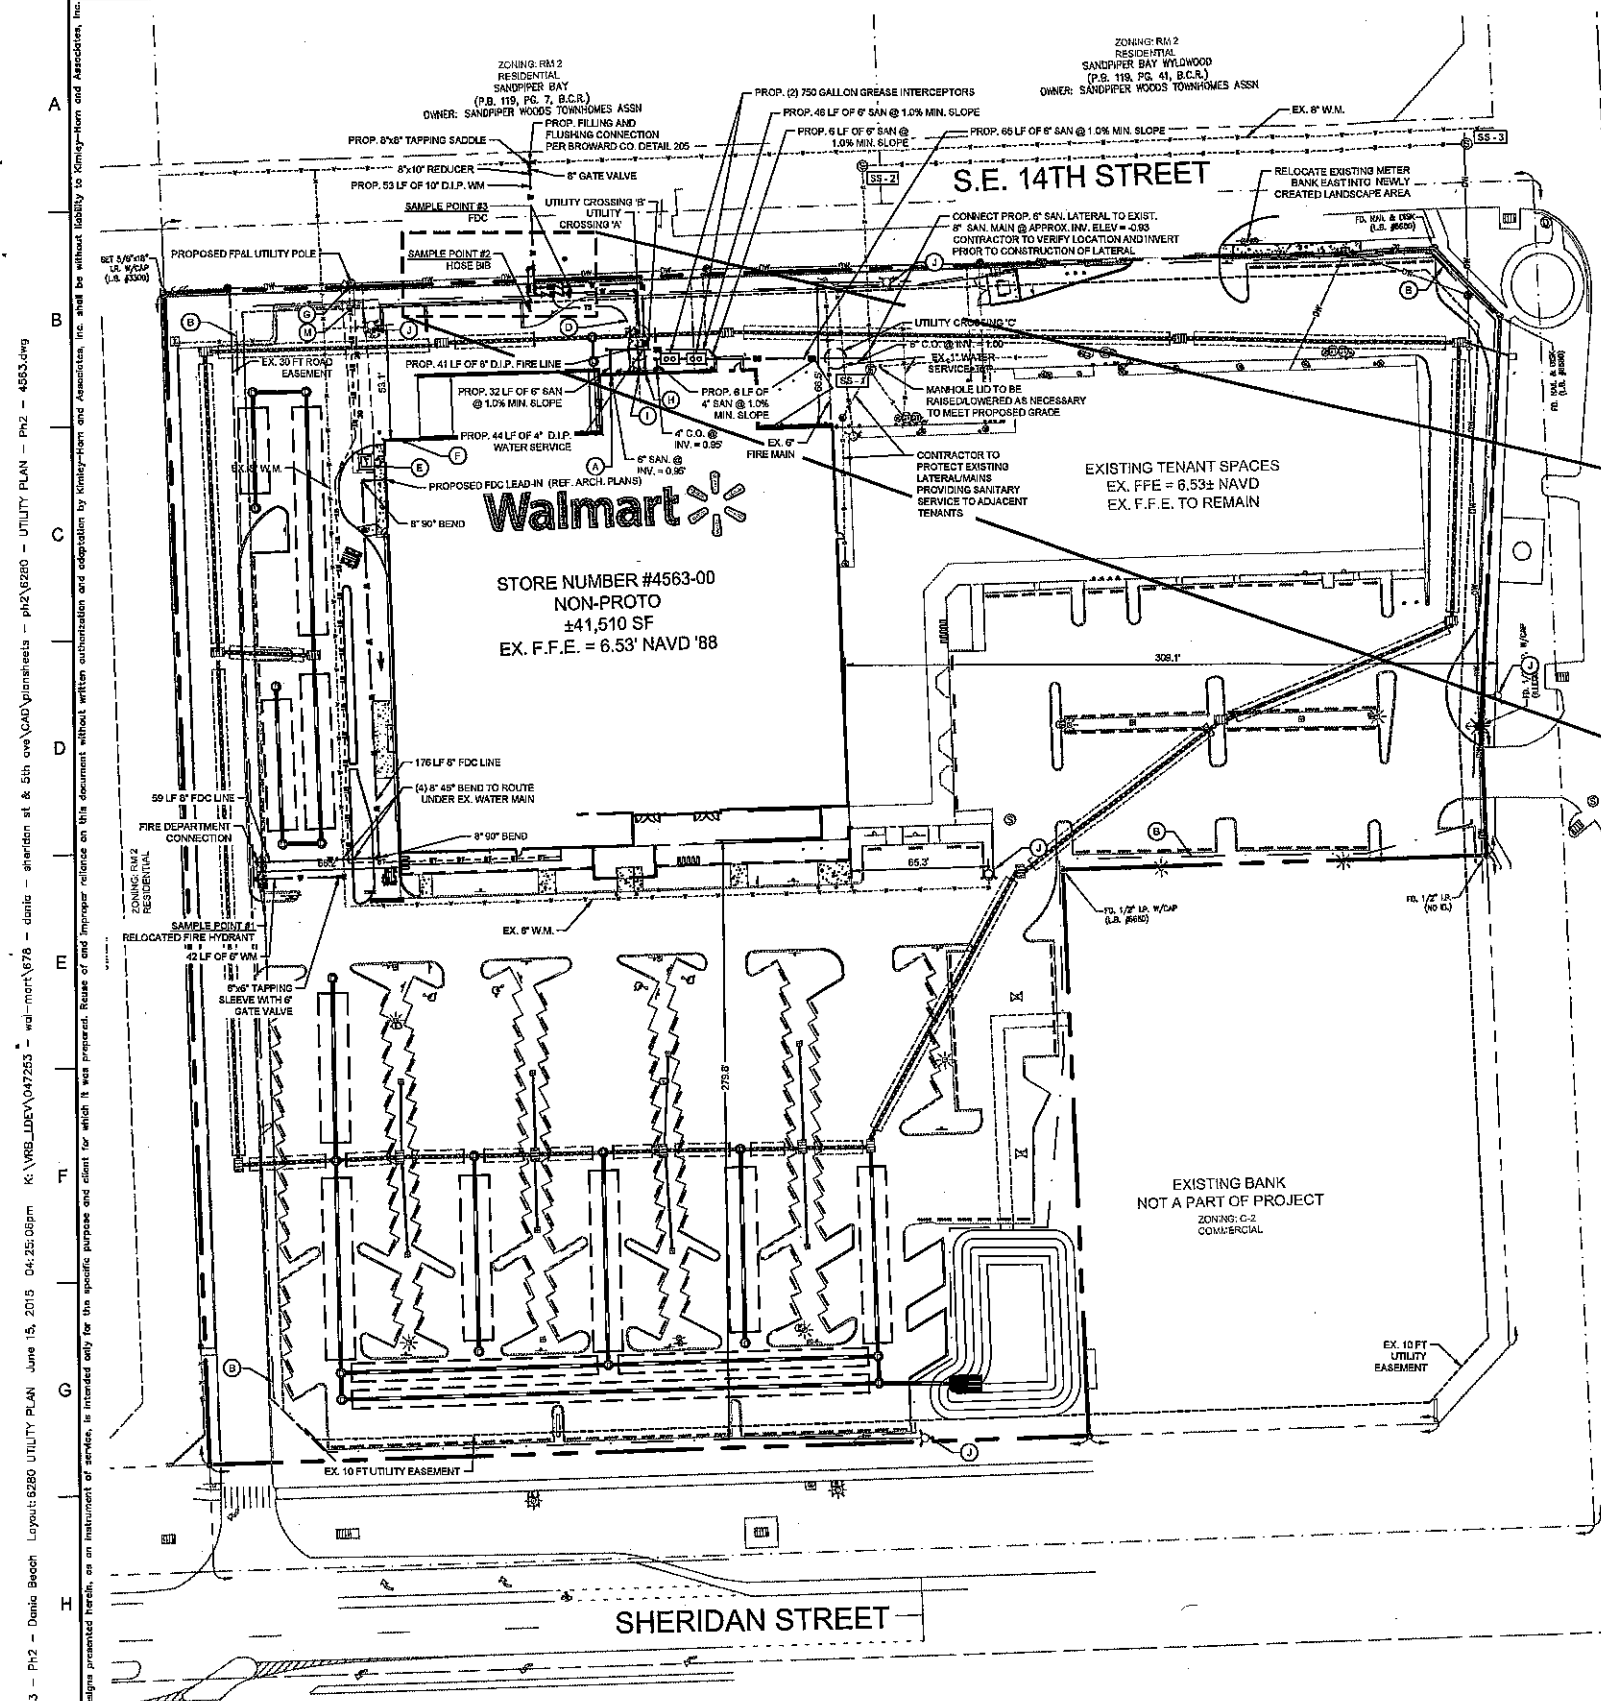

UTILITY NOTES

- ALL FILL MATERIAL IS TO BE IN PLACE, AND COMPACTED BEFORE INSTALLATION OF PROPOSED UTILITIES.
- CONTRACTOR SHALL NOTIFY THE UTILITY AUTHORITIES INSPECTORS 72 HOURS BEFORE CONNECTING TO ANY EXISTING LINE.
- SANITARY SEWER PIPE SHALL BE AS FOLLOWS:
PVC SERVICED 15"
WATER LINES SHALL BE AS FOLLOWS:
4" - 12" PVC C-90 PER ASTM D2241, DR15
14" - 48" PVC C-90 PER ASTM D2241, DR 18
CLASS 200 UNDER COUNTRY ROADS, OTHERWISE CLASS 150
4" - 12" DUCTILE IRON PIPE PER AWWA C151, PRESSURE CLASS 350
14" - 36" DUCTILE IRON PIPE PER AWWA C151, PRESSURE CLASS 250
3" AND SMALLER, EITHER PIPE TYPE "K" (BOTT) PER
ASME 16.22 OR PVC, 200 P.S.I. PER ASTM D1784 AND D2241.
- MINIMUM TRENCH WIDTH SHALL BE 2 FEET.
- ALL WATER CONDUITS TO BE MECHANICAL JOINTS WITH THURST BLOCKING AS CALLED OUT IN SPECIFICATIONS.
- ALL UTILITIES SHOULD BE KEPT TEN (10) FEET (PARALLEL) OR WHEN CROSSING 16" CLEARANCE: OUTSIDE EDGE OF PIPE TO OUTSIDE EDGE OF PIPE.
- CONTRACTOR SHALL MAINTAIN A MINIMUM OF 4" COVER ON ALL WATER LINES.
- IN THE EVENT OF A VERTICAL CONFLICT BETWEEN WATER LINES, SANITARY LINES, STORM LINES AND GAS LINES EXISTING AND PROPOSED, THE SANITARY LINE SHALL BE DUCTILE IRON PIPE WITH MECHANICAL JOINTS AT LEAST 10 FEET ON BOTH SIDES OF CROSSING. THE WATER LINE SHALL HAVE MECHANICAL JOINTS WITH APPROPRIATE THURST BLOCKING AS REQUIRED TO PROVIDE A MINIMUM OF 18" CLEARANCE. MEETING REQUIREMENTS OF ANSI A21.10 OR ANSI 21.11 (AWWA C-151) (CLASS 50).
- LINES UNDERGROUND SHALL BE INSTALLED, INSPECTED AND APPROVED BEFORE BACKFILLING.
- TOPS OF EXISTING MANHOLES SHALL BE RAISED AS NECESSARY TO BE FLUSH WITH PROPOSED PAVEMENT ELEVATIONS.
- ALL CONCRETE OR ENCASEMENTS SHALL HAVE A MINIMUM 28 DAY COMPRESSION STRENGTH AT 3000 P.S.I.
- EXISTING UTILITIES SHALL BE VERIFIED IN FIELD PRIOR TO INSTALLATION OF ANY NEW LINES.
- REFER TO INTERIOR PLUMBING DRAWINGS FOR TIE-IN OF ALL UTILITIES.
- CONTRACTOR IS RESPONSIBLE FOR COMPLYING TO THE SPECIFICATIONS OF THE LOCAL AUTHORITIES (DANA BEACH) WITH REGARDS TO MATERIALS AND INSTALLATION OF THE WATER AND SEWER LINES.
- CONTRACTOR IS SPECIFICALLY CAUTIONED THAT THE LOCATION AND/OR ELEVATION OF EXISTING UTILITIES AS SHOWN ON THESE PLANS IS BASED ON RECORDS OF THE VARIOUS UTILITY COMPANIES AND WHERE POSSIBLE, MEASUREMENTS TAKEN IN THE FIELD. THE INFORMATION IS NOT TO BE RELIED ON AS BEING EXACT OR COMPLETE. THE CONTRACTOR MUST CALL THE APPROPRIATE UTILITY COMPANIES AT LEAST 72 HOURS BEFORE ANY EXCAVATION TO REQUEST EXACT FIELD LOCATION OF UTILITIES. IT SHALL BE THE RESPONSIBILITY OF THE CONTRACTOR TO RELOCATE ALL EXISTING UTILITIES WHICH CONFLICT WITH THE PROPOSED IMPROVEMENTS SHOWN ON THE PLANS.
- CONTRACTOR SHALL BE RESPONSIBLE FOR ALL NECESSARY INSPECTIONS AND/OR CERTIFICATIONS REQUIRED BY CODES AND/OR UTILITY SERVICE COMPANIES. THIS AND THE FINAL CONNECTIONS OF THE SERVICE SHALL BE COMPLETED 30 DAYS PRIOR TO STORE POSSESSION.
- CONTRACTOR SHALL COORDINATE WITH ALL UTILITY COMPANIES FOR INSTALLATION REQUIREMENTS AND SPECIFICATIONS.
- REFER TO BUILDING PLANS FOR SITE LIGHTING ELECTRICAL PLAN.
- CONTRACTOR TO RE-LAMP EXISTING BUILDING MOUNTED ENTICES.
- CONTRACTOR TO CUT, REWORK AND FLAG AT THE MANHOLE AND WATER SERVICE LATERALS CURRENTLY SERVING THE PROPOSED TAKE OVER SPACE.
- THE EXISTING UTILITY POLES AT THE NORTH PROPERTY LINE ARE LACKING THE NECESSARY CAPACITY FOR THE NEW ELECTRICAL SERVICE. A NEW TOWER POLE IS PROPOSED IN THE NW CORNER OF THE PROPERTY AND IS TO BE INSTALLED BY FPAL. THE CONTRACTOR SHALL COORDINATE THE INSTALLATION OF THE TOWER UTILITY POLE AND RISER WITH FPAL. CONTRACTOR SHALL INSTALL PRIMARY CONDUIT TO UTILITY POLE RISER.
- CONTRACTOR TO DIG TEST PITS AT PROPOSED SANITARY AND GATE VALVE LOCATIONS AND CONFIRM TIE-IN ELEVATION. ANY CONFLICT WITH EXISTING UTILITIES SHALL BE IDENTIFIED PRIOR TO SHOP DRAWING SUBMITTAL.
- CONTRACTOR IS RESPONSIBLE FOR THE COORDINATION AND INSTALLATION OF THE DART CONTAINMENT SYSTEM. CONTRACTOR SHALL COORDINATE WITH THE ARCHITECT FOR BUILDING CONSTRUCTION LOCATION AND CONNECTIONS TO THE DART SYSTEM.
- DUCTILE IRON WATER PIPE SHALL BE PER AWWA C151, PRESSURE CLASS 350.
- PERFORM DISINFECTION OF INSTALLED WATER PIPE PER AWWA C600-13.
- TEST AND DISINFECTION OF THE SPRINKLER LINE SHALL BE PER AWWA C600-13 (FOR DFP PIPE) OR AWWA C605-13 (FOR PVC PIPE). THE ALLOWABLE LEAKAGE SHALL BE 2 QUARTS PER HOUR PER 100 JOINTS ACCORDING TO THE TEST SPECIFICATIONS.
- ALL ABOVE GROUND WATER MAINS ARE TO BE PAINTED BLUE.

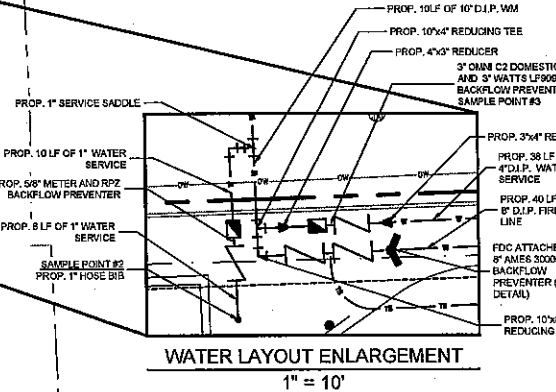

EXISTING SANITARY SEWER SCHEDULE *

SS-#	STR. TYPE	RIM ELEV.	INVERT ELEVATION	PIPE SIZE / TYPE
SS-1	EXISTING MANHOLE	6.44	-0.80 (S) -0.83 (N)	8"
SS-2	EXISTING MANHOLE	4.43	-4.15 (S) -4.10 (N) -4.30 (E)	8"
SS-3	EXISTING MANHOLE	3.55	-5.62 (S) -5.62 (W) -5.85 (NE)	10"

WATER, SANITARY SEWER, AND WASTE DEMAND

PROTOTYPE & SIZES	PROTOTYPE FIXTURE UNITS	DOMESTIC WATER PEAK FLOW (GPM)	AVERAGE SEWER LOAD - 90% DOMESTIC (GPD)	AVERAGE DOMESTIC WATER DEMAND (GPD)	SOLID WASTE (LBS/DAY)
WNM 415F	171	88	1,100	1,232	200



WATERMAIN PRESSURE TESTS SHALL BE IN ACCORDANCE WITH AWWA 600-10 OR LATEST REVISION FOR D.I.P. AND AWWA 605-13 OR LATEST REVISION FOR PVC.

ALLOWABLE LEAKAGE SHALL NOT EXCEED THE FORMULA OF:
L (GALLONS PER HOUR) = 50(F) / 148,000
L = ALLOWABLE LEAKAGE IN GALLONS PER HOUR
S = LENGTH OF PIPE TESTED IN FEET
D = NOMINAL DIAMETER OF PIPE IN INCHES
P = AVERAGE TEST PRESSURE DURING TEST IN PSI

WATERMANS SHALL BE DISINFECTED IN ACCORDANCE WITH AWWA 605-05 OR LATEST REVISION.

WATERMANS SHALL BE INSTALLED WITH A MINIMUM 36" COVER FOR PVC AND 30" COVER FOR DUCTILE IRON PIPE

ALL WATERMANS SHALL COMPLY WITH THE COLOR CODING REQUIREMENTS OF FAC 62-553.320(2)(b)(3).

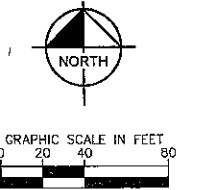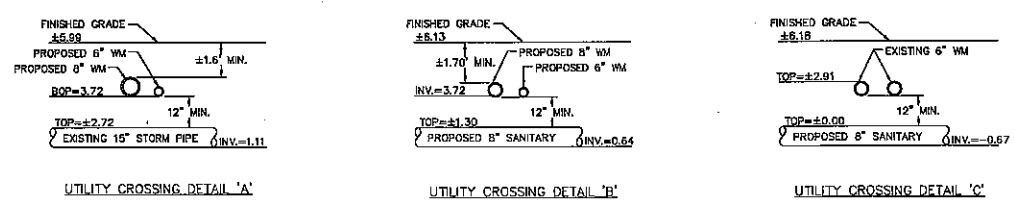

ALERT TO CONTRACTOR:

- THE PRESENCE OF GROUNDWATER SHOULD BE ANTICIPATED ON THIS PROJECT. CONTRACTOR'S BID SHALL INCLUDE CONSIDERATION FOR THIS ISSUE. WHEN PERFORMING GRADING OPERATIONS DURING PERIODS OF HIGH WATER, PRECIPITATION, DRAINAGE AND GROUND WATER MANAGEMENT TO CONTROL MOISTURE OF SOILS. REFER TO MASTER SITE SPECIFICATIONS.
- ALL W/M GENERAL CONTRACTOR WORK TO BE COMPLETED (EARTHWORK, FINAL UTILITIES, AND FINAL GRADING) BY THE MILESTONE DATE IN PROJECT DOCUMENTS. OUTLOT AREA TO BE KEPT FREE OF JOB TRAILERS AND STORAGE AFTER THE CONTRACT MILESTONE DATE FOR THE OUTLOT. W/M GENERAL CONTRACTOR TO PROVIDE CLEAR ACCESS FOR OUTLOT CONTRACTOR TO THE SPECIFIC PARCEL AT ALL TIMES AFTER MILESTONE DATE. PURCHASER OF OUTLOT TO PROVIDE PERMIT DOCUMENTS AND SWPPP REQUIRED BY STATE/LOCAL REQUIREMENTS FOR SPECIFIC OUTLOT.















Kimley-Horn
DESIGN ENGINEER
SCALE: AS SHOWN
DESIGNED BY: CHANGING ARCHITECT, P.C.
DRAWN BY: J. H. HORN
CHECKED BY: J. H. HORN
DATE: 10/22/14
PROJECT NO. 147253678
SHEET NUMBER 6280

Walmart STORE #4563-00
DANIA BEACH, FL
WAL-MART STORES EAST, LP
DANIA BEACH

UTILITY PLAN

DATE: 10/22/14
PROJECT NO. 147253678
SHEET NUMBER 6280


Noted By: Patagonia, John Sheet: Walmart-4563 - Ph2 - Dana Beach Layout: B280 UTILITY PLAN June 15, 2015 04:25:06pm K:\WB_DEV\047253 - Wal-Mart\676 - Dana - sharden at 5th ave\CAD\ymathista - ph2\B280 - UTILITY PLAN - Ph2 - 4563.dwg
 This document, together with the concepts and design presented herein, is intended only for the specific purpose and client for which it was prepared. Release of and/or reuse of this document without written authorization and adaptation by Kimley-Horn and Associates, Inc. shall be without liability to Kimley-Horn and Associates, Inc.

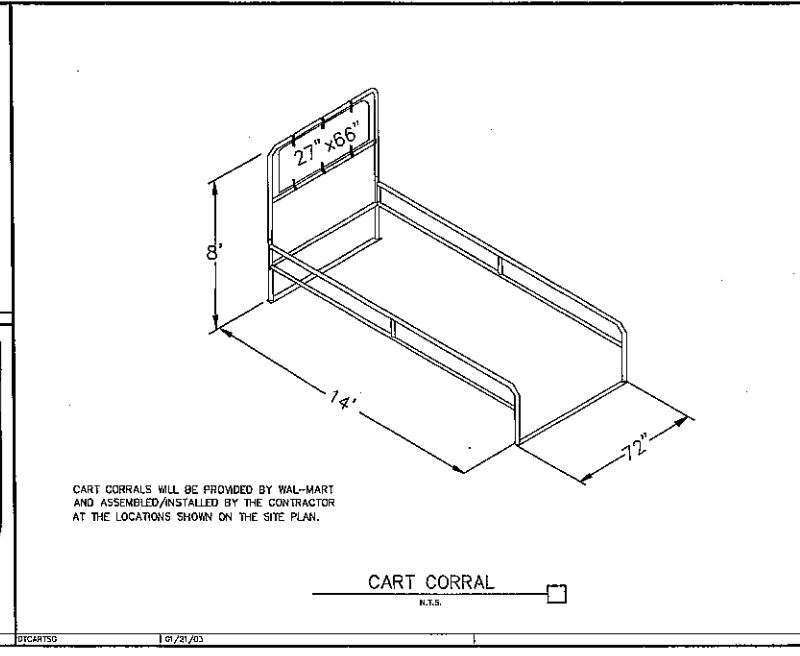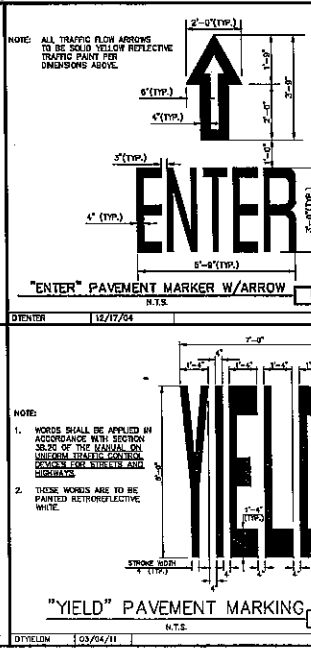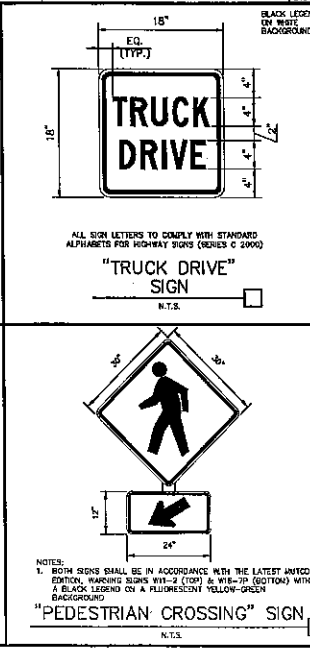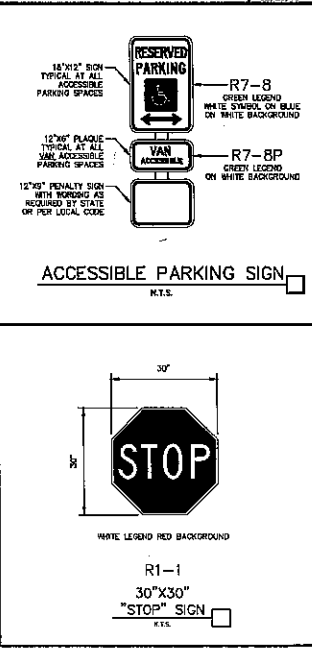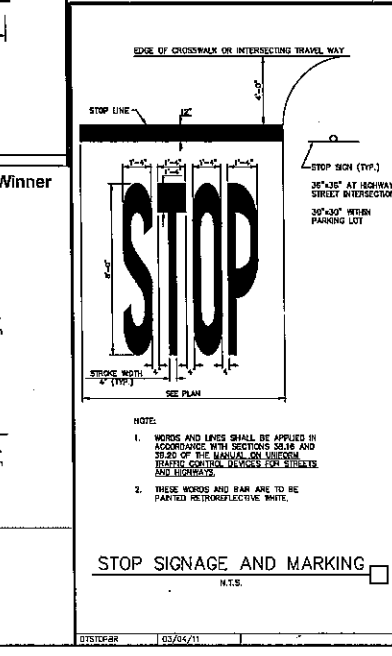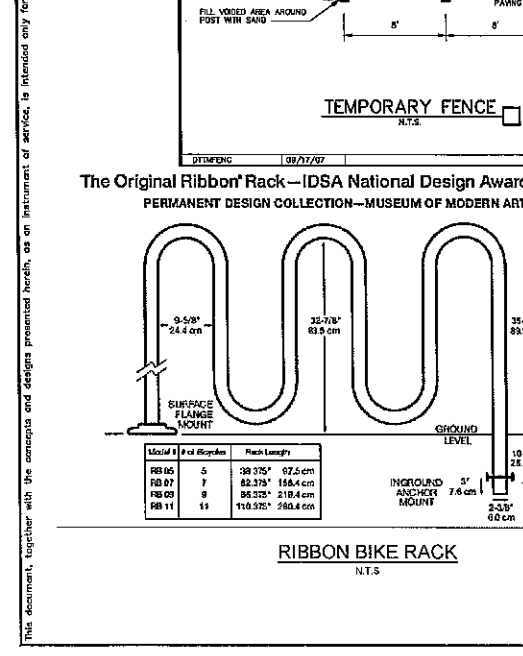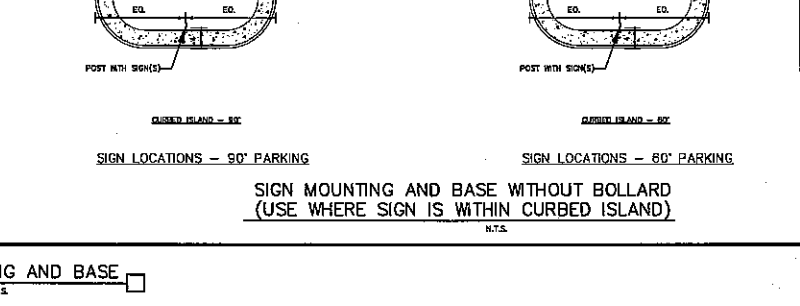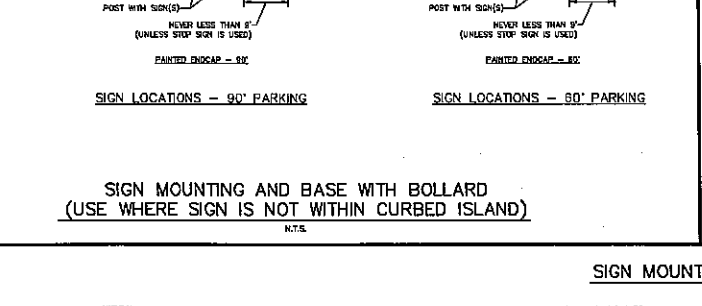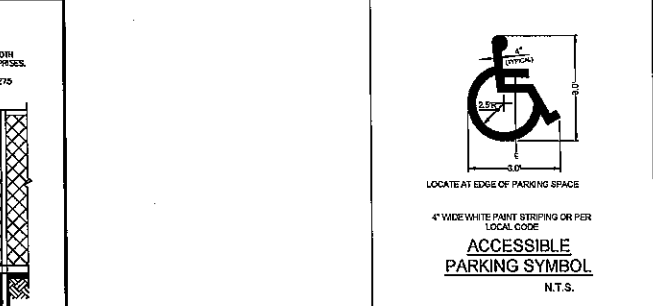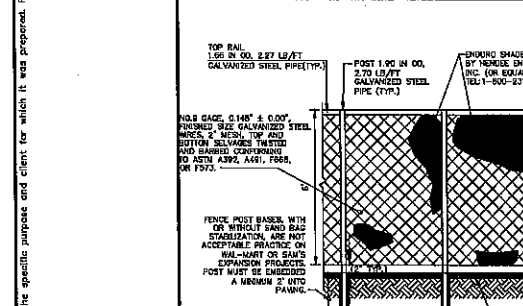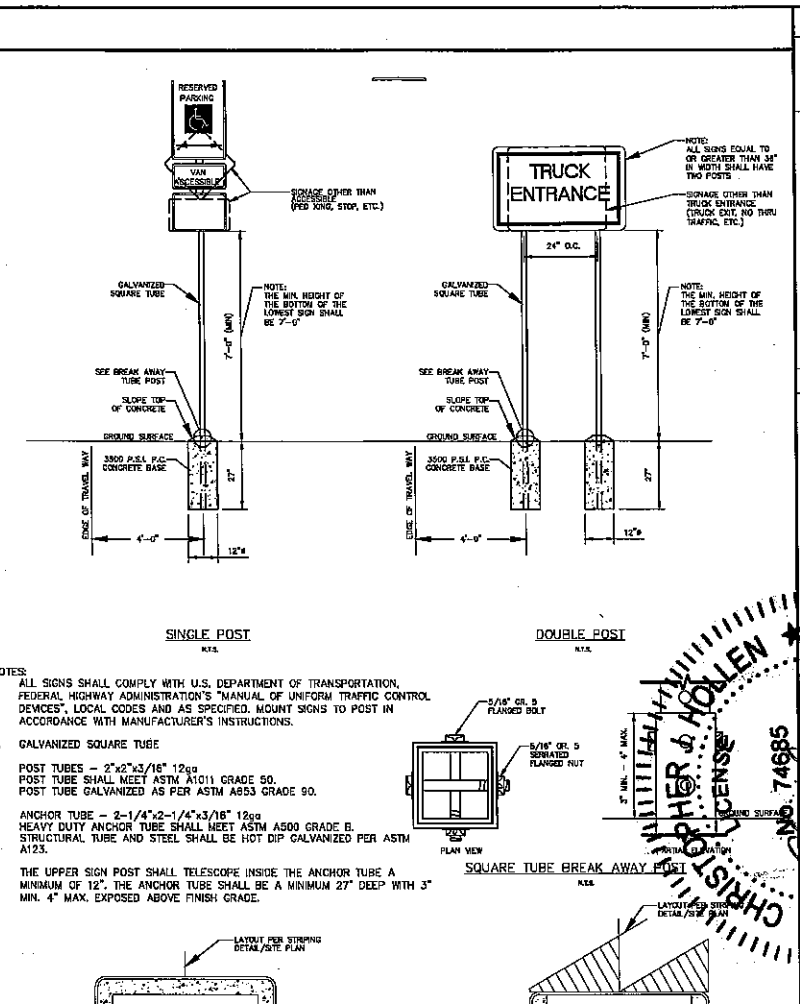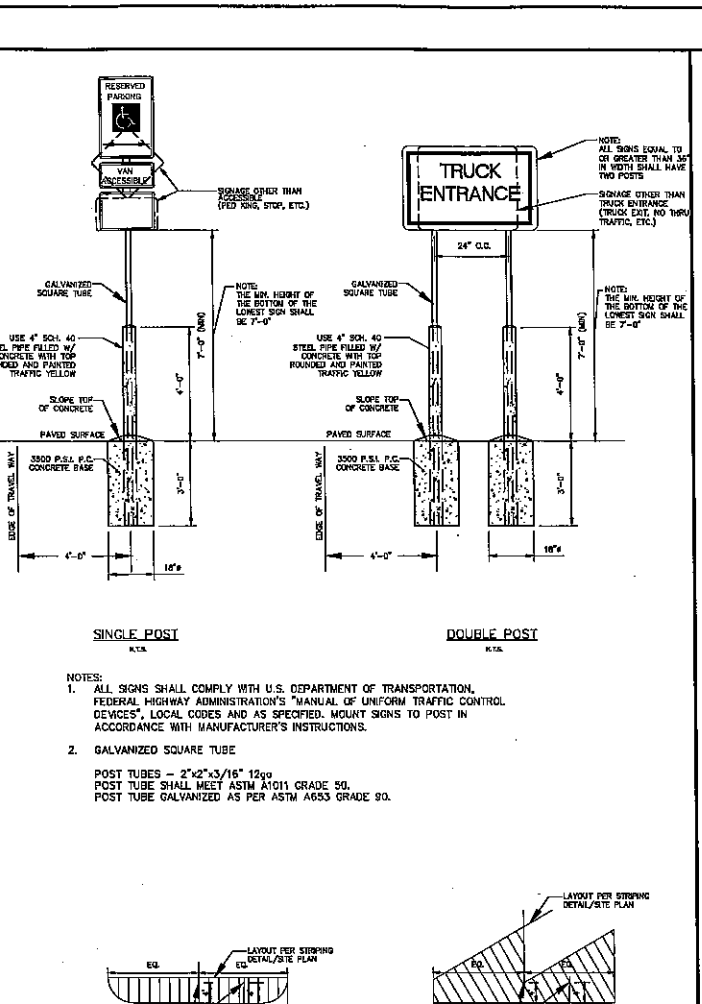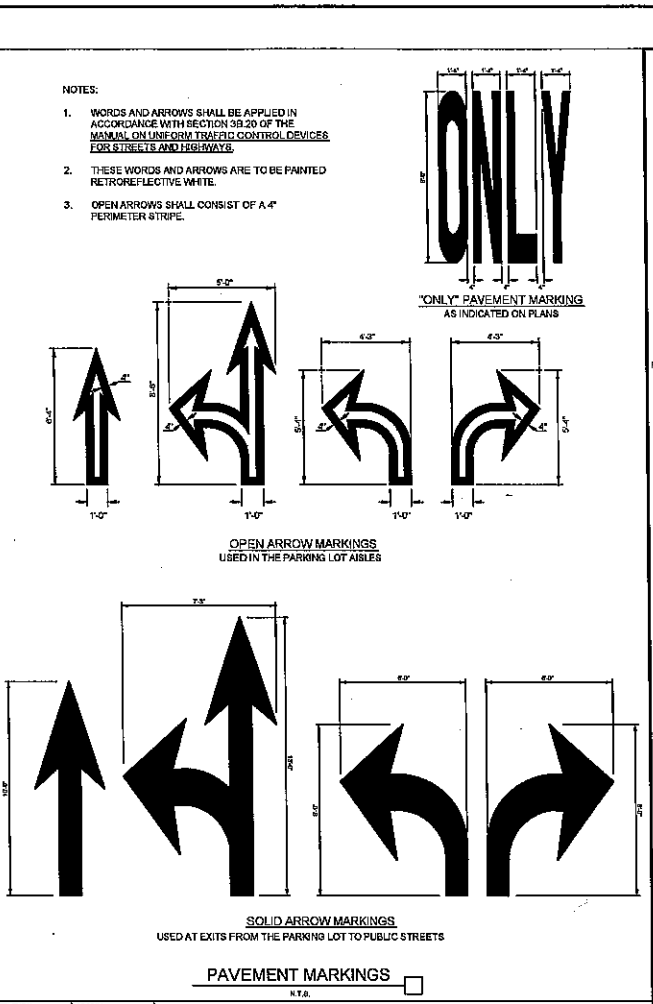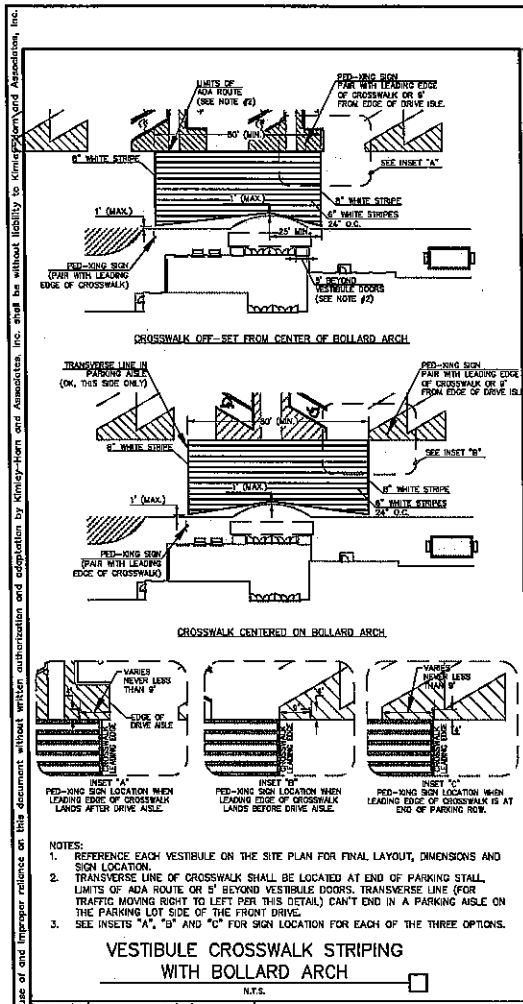

Kimley-Horn & Horn, Inc.
 PROFESSIONAL ENGINEERS
 No. 74685
 STATE OF FLORIDA
 DESIGNER: [Signature]
 DRAWN BY: [Signature]
 CHECKED BY: [Signature]

Walmart STORE #4563-00
 DANIA BEACH, FL
 WAL-MART STORES EAST, LP
 DANIA BEACH, FL

DATE: 10/22/14
 PROJECT NO. 147253678
 SHEET NUMBER: 6310

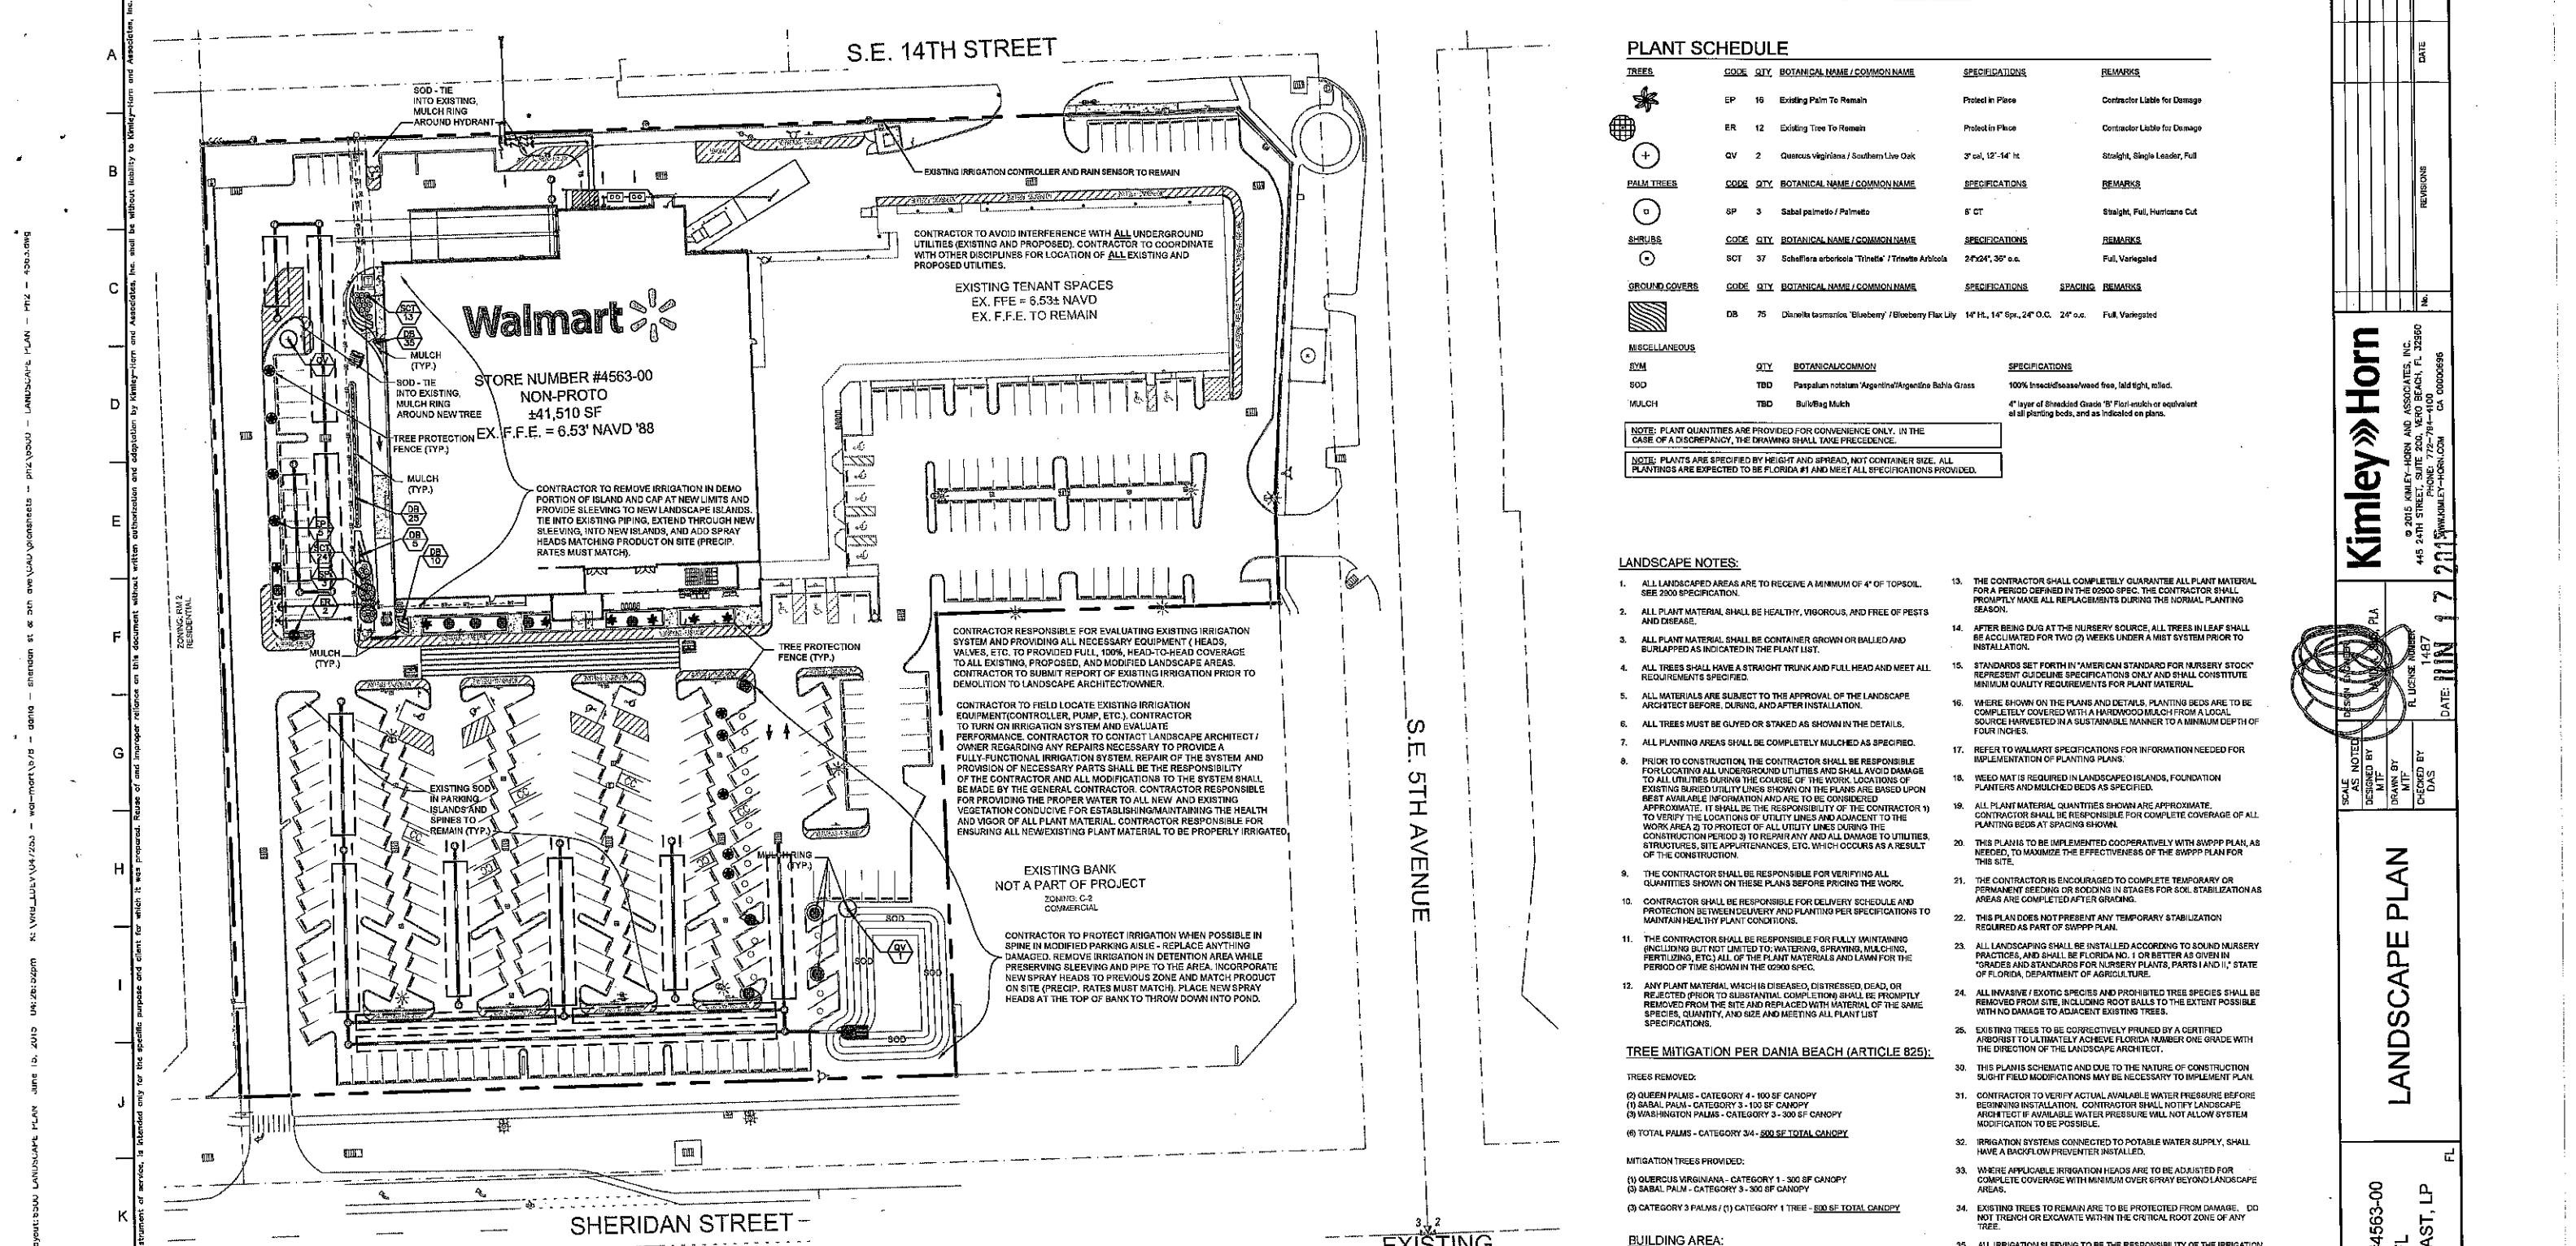

PLANT SCHEDULE

TREES	CODE	QTY	BOTANICAL NAME / COMMON NAME	SPECIFICATIONS	REMARKS	
★	EP	16	Existing Palm To Remain	Protected in Place	Contractor Liable for Damage	
★	ER	12	Existing Tree To Remain	Protected in Place	Contractor Liable for Damage	
+	QV	2	Quercus virginiana / Southern Live Oak	3" cal, 12'-14" ht	Straight, Single Leader, Full	
PALM TREES	CODE	QTY	BOTANICAL NAME / COMMON NAME	SPECIFICATIONS	REMARKS	
○	SP	3	Sabal palmetto / Palmetto	6' CT	Straight, Full, Hurricane Cut	
SHRUBS	CODE	QTY	BOTANICAL NAME / COMMON NAME	SPECIFICATIONS	REMARKS	
○	SCT	37	Schefflera arboricola 'Tilinea' / Tiltone Arboricola	2'x24", 30" o.c.	Full, Variegated	
GROUND COVERS	CODE	QTY	BOTANICAL NAME / COMMON NAME	SPECIFICATIONS	SPACING	REMARKS
■	DB	75	Dianella barbata / Blueberry / Blueberry Flax Lily	14" H, 14" Sp, 24" O.C.	24" o.c.	Full, Variegated
MISCELLANEOUS	QTY	BOTANICAL COMMON	SPECIFICATIONS			
ERM	TBD	Paspalum notatum / Argentine Bahia Grass	100% Insecticide/Weed free, laid tight, mtd.			
SOD	TBD					
MULCH	TBD	Bulk Bag Mulch	4" layer of Shredded Grade 15" Flr mulch or equivalent of all planting beds, and as indicated on plans.			

NOTE: PLANT QUANTITIES ARE PROVIDED FOR CONVENIENCE ONLY. IN THE CASE OF A DISCREPANCY, THE DRAWING SHALL TAKE PRECEDENCE.

NOTE: PLANTS ARE SPECIFIED BY HEIGHT AND SPREAD, NOT CONTAINER SIZE. ALL PLANTINGS ARE EXPECTED TO BE FLORIDA #1 AND MEET ALL SPECIFICATIONS PROVIDED.

- ### LANDSCAPE NOTES:
- ALL LANDSCAPE AREAS ARE TO RECEIVE A MINIMUM OF 4" OF TOPSOIL. SEE 2300 SPECIFICATION.
 - ALL PLANT MATERIAL SHALL BE HEALTHY, VIGOROUS, AND FREE OF PESTS AND DISEASE.
 - ALL PLANT MATERIAL SHALL BE CONTAINER GROWN OR BALLED AND BURLAPPED AS INDICATED IN THE PLANT LIST.
 - ALL TREES SHALL HAVE A STRAIGHT TRUNK AND FULL HEAD AND MEET ALL REQUIREMENTS SPECIFIED.
 - ALL MATERIALS ARE SUBJECT TO THE APPROVAL OF THE LANDSCAPE ARCHITECT BEFORE CURBS AND AFTER INSTALLATION.
 - ALL TREES MUST BE GUYYED OR STAKED AS SHOWN IN THE DETAILS.
 - ALL PLANTING AREAS SHALL BE COMPLETELY MULCHED AS SPECIFIED.
 - PRIOR TO CONSTRUCTION, THE CONTRACTOR SHALL BE RESPONSIBLE FOR LOCATING ALL UNDERGROUND UTILITIES AND SHALL AVOID DAMAGE TO ALL UTILITIES DURING THE COURSE OF THE WORK. LOCATIONS OF EXISTING BURIED UTILITY LINES SHOWN ON THE PLANS ARE BASED UPON BEST AVAILABLE INFORMATION AND ARE TO BE CONSIDERED APPROXIMATE. IT SHALL BE THE RESPONSIBILITY OF THE CONTRACTOR TO VERIFY THE LOCATIONS OF UTILITY LINES AND ADJACENT TO THE WORK AREA TO PROTECT OF ALL UTILITY LINES DURING THE CONSTRUCTION PERIOD TO REPAIR ANY AND ALL DAMAGE TO UTILITIES, STRUCTURES, SITE APPURTENANCES, ETC. WHICH OCCURS AS A RESULT OF THE CONSTRUCTION.
 - THE CONTRACTOR SHALL BE RESPONSIBLE FOR VERIFYING ALL QUANTITIES SHOWN ON THESE PLANS BEFORE PROCEEDING WITH THE WORK.
 - CONTRACTOR SHALL BE RESPONSIBLE FOR DELIVERY SCHEDULE AND PROTECTION BETWEEN DELIVERY AND PLANTING PER SPECIFICATIONS TO MAINTAIN HEALTHY PLANT CONDITIONS.
 - THE CONTRACTOR SHALL BE RESPONSIBLE FOR FULLY MAINTAINING (INCLUDING BUT NOT LIMITED TO: WATERING, SPRAYING, MULCHING, FERTILIZING, ETC.) ALL OF THE PLANT MATERIALS AND LAWN FOR THE PERIOD OF TIME SHOWN IN THE 02300 SPEC.
 - ANY PLANT MATERIAL WHICH IS DISEASED, DISTRESSED, DEAD, OR REJECTED PRIOR TO SUBSTANTIAL COMPLETION SHALL BE PROMPTLY REMOVED FROM THE SITE AND REPLACED WITH MATERIAL OF THE SAME SPECIES, QUANTITY, AND SIZE AND MEETING ALL PLANT LIST SPECIFICATIONS.
 - THE CONTRACTOR SHALL COMPLETELY GUARANTEE ALL PLANT MATERIAL FOR A PERIOD DEFINED IN THE 02300 SPEC. THE CONTRACTOR SHALL PROMPTLY MAKE ALL REPLACEMENTS DURING THE NORMAL PLANTING SEASON.
 - AFTER BEING DUG AT THE NURSERY SOURCE, ALL TREES IN LEAF SHALL BE ACCUMULATED FOR TWO (2) WEEKS UNDER A MIST SYSTEM PRIOR TO INSTALLATION.
 - STANDARDS SET FORTH IN 'AMERICAN STANDARD FOR NURSERY STOCK' REPRESENT GUIDELINE SPECIFICATIONS ONLY AND SHALL CONSTITUTE MINIMUM QUALITY REQUIREMENTS FOR PLANT MATERIAL.
 - WHERE SHOWN ON THE PLANS AND DETAILS, PLANTING BEDS ARE TO BE COMPLETELY COVERED WITH A HARDWOOD MULCH FROM A LOCAL SOURCE HARVESTED IN A SUSTAINABLE MANNER TO A MINIMUM DEPTH OF FOUR INCHES.
 - REFER TO WALMART SPECIFICATIONS FOR INFORMATION NEEDED FOR IMPLEMENTATION OF PLANTING PLANS.
 - WEED MAT IS REQUIRED IN LANDSCAPE ISLANDS, FOUNDATION PLANTERS AND MULCHED BEDS AS SPECIFIED.
 - ALL PLANT MATERIAL QUANTITIES SHOWN ARE APPROXIMATE. CONTRACTOR SHALL BE RESPONSIBLE FOR COMPLETE COVERAGE OF ALL PLANTING BEDS AT SPACING SHOWN.
 - THIS PLAN IS TO BE IMPLEMENTED COOPERATIVELY WITH SWPPP PLAN, AS NEEDED, TO MAXIMIZE THE EFFECTIVENESS OF THE SWPPP PLAN FOR THIS SITE.
 - THE CONTRACTOR IS ENCOURAGED TO COMPLETE TEMPORARY OR PERMANENT SEEDING OR SODDING IN STAGES FOR SOIL STABILIZATION AS AREAS ARE COMPLETED AFTER GRADING.
 - THIS PLAN DOES NOT PRESENT ANY TEMPORARY STABILIZATION REQUIRED AS PART OF SWPPP PLAN.
 - ALL LANDSCAPING SHALL BE INSTALLED ACCORDING TO SOUND NURSERY PRACTICES, AND SHALL BE FLORIDA NO. 1 OR BETTER AS GIVEN IN 'GRADES AND STANDARDS FOR NURSERY PLANTS, PARTS I AND II', STATE OF FLORIDA, DEPARTMENT OF AGRICULTURE.
 - ALL INVASIVE / EXOTIC SPECIES AND PROHIBITED TREE SPECIES SHALL BE REMOVED FROM SITE, INCLUDING ROOT BALLS TO THE EXTENT POSSIBLE WITH NO DAMAGE TO ADJACENT EXISTING TREES.
 - EXISTING TREES TO BE CORRECTIVELY PRUNED BY A CERTIFIED ARBORIST TO ULTIMATELY ACHIEVE FLORIDA NUMBER ONE GRADE WITH THE DIRECTION OF THE LANDSCAPE ARCHITECT.
 - THIS PLAN IS SCHEMATIC AND DUE TO THE NATURE OF CONSTRUCTION SLIGHT FIELD MODIFICATIONS MAY BE NECESSARY TO IMPLEMENT PLAN.
 - CONTRACTOR TO VERIFY ACTUAL AVAILABLE WATER PRESSURE BEFORE BEGINNING INSTALLATION. CONTRACTOR SHALL NOTIFY LANDSCAPE ARCHITECT IF AVAILABLE WATER PRESSURE WILL NOT ALLOW SYSTEM MODIFICATION TO BE POSSIBLE.
 - IRRIGATION SYSTEMS CONNECTED TO POTABLE WATER SUPPLY, SHALL HAVE A BACKFLOW PREVENTER INSTALLED.
 - WHERE APPLICABLE IRRIGATION HEADS ARE TO BE ADJUSTED FOR COMPLETE COVERAGE WITH MINIMUM OVER SPRAY BEYOND LANDSCAPE AREAS.
 - EXISTING TREES TO REMAIN ARE TO BE PROTECTED FROM DAMAGE. DO NOT TRENCH OR EXCAVATE WITHIN THE CRITICAL ROOT ZONE OF ANY TREE.
 - ALL IRRIGATION BLEEVING TO BE THE RESPONSIBILITY OF THE IRRIGATION CONTRACTOR. ELECTRICAL WIRES FOR IRRIGATION VALVES AND IRRIGATION LINES ARE TO BE PLACED IN SEPARATE BLEEVES.
 - IRRIGATION CONTRACTOR SHALL REVIEW WINTERIZATION PROCEDURES FOR IRRIGATION SYSTEM WITH OWNERS REPRESENTATIVE.
 - ALL PLANT MATERIAL IN TREE HOLDING AREAS SHALL BE MANUALLY WATERED/IRRIGATED TO KEEP MOIST UNTIL PLANTED.
 - CONTRACTOR TO PROVIDE PERMANENT BENCH MARKS ON ALL CURBS LINES AT RELATED BLEEVING LOCATIONS (TYP.).
 - A TREE REMOVAL PERMIT WILL BE REQUIRED, BEFORE THE DEMOLITION OF ANY ONSITE TREES.

TREE MITIGATION PER DANIA BEACH (ARTICLE 825):

TREES REMOVED:

- (2) QUEEN PALMS - CATEGORY 4 - 100 SF CANOPY
- (1) SABAL PALM - CATEGORY 3 - 100 SF CANOPY
- (2) WASHINGTON PALMS - CATEGORY 3 - 300 SF CANOPY
- (8) TOTAL PALMS - CATEGORY 34 - 500 SF TOTAL CANOPY

MITIGATION TREES PROVIDED:

- (1) QUERCUS VIRGINIANA - CATEGORY 1 - 300 SF CANOPY
- (3) SABAL PALM - CATEGORY 3 - 300 SF CANOPY
- (3) CATEGORY 3 PALMS / (1) CATEGORY 1 TREE - 500 SF TOTAL CANOPY

BUILDING AREA:

EXISTING BUILDING AREA = 68,370 SF
PROPOSED BUILDING AREA = 68,370 SF

VEHICULAR USE AREA:

EXISTING VUA = 183,482 SF
VUA TO BE REMOVED = 7,224 SF
VUA TO BE ADDED = 2,282 SF
VUA MODIFICATION TOTAL = 8,618 SF (5.86% CHANGE IN VUA)
PROPOSED TOTAL VUA = 190,860 SF

CONTRACTOR SHALL REFER TO ARCHITECTURAL PLANS FOR EXACT LOCATION AND DIMENSIONS OF VESTIBULE, LOADED PORCHES, RAMPS AND TRUCK DOCKS, PRECISE BUILDING DIMENSIONS AND EXACT UTILITY ENTRANCE LOCATIONS.

EXISTING SOD WITHIN PARKING LOT ISLANDS TO REMAIN, UNLESS PARKING ISLANDS ARE DISTURBED BY CONSTRUCTION. IN THE EVENT OF ISLAND DISTURBANCE, PARKING ISLANDS SHALL BE RESTORED PER THE 02300 SPECIFICATION WITH WEED MAT AND MULCH STABILIZATION.



NOTE: ALL PROPOSED LANDSCAPE PLANTING AREAS TO BE EXCAVATED TO A MINIMUM DEPTH OF 24" AS NECESSARY TO CONTAIN APPROPRIATE PLANTING MIX AS SPECIFIED IN SECTION 2900, PART 2.5 TOPSOIL. CONTRACTOR SHALL BE RESPONSIBLE FOR PROTECTION OF ALL EXISTING UTILITIES, IRRIGATION LINES, WIRING, STRUCTURES, LANDSCAPE, ETC. WHICH ARE SCHEDULED TO BE RETAINED/REUSED.

WEED MAT IS TO BE UTILIZED WITHIN ALL PROPOSED, MULCHED PLANTING BEDS PER SPECIFICATIONS, SECTION 2900, 2.14.A.

GRAPHIC SCALE IN FEET
0 20 40 80

811
Know what's below.
Call before you dig.

NOTE: ALL TREES ARE TO BE PROTECTED FROM DAMAGE. NO VEHICULAR PARKING, STORAGE OF MATERIALS OR EQUIPMENT, CLEANING OF EQUIPMENT, EQUIPMENT WASH OUT OR ANY OTHER ACTION WHICH MAY CAUSE AN ADVERSE EFFECT ON EXISTING OR FUTURE PLANTING IS TO OCCUR IN OR AROUND TREES IN LANDSCAPE AREAS WHICH MAY BE AFFECTED.

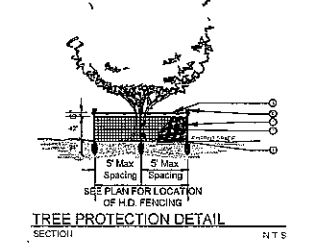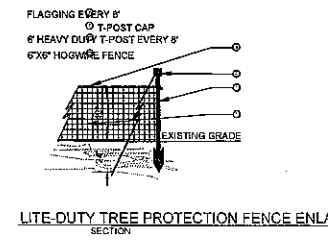

- ### NOTES:
- TREES PROPOSED FOR RELOCATION ARE TO BE PROPERLY WATERED PRIOR TO RELOCATION AND THE PROPER ROOT BALL DIAMETER BASED ON THE TREE TRUNK DIAMETER (SPECIFIED BELOW) TO BE ROOT PRUNED, PROPER STAKING, WATERING AND PROTECTION IS REQUIRED AND ANSI Z300 AND Z60.1 SPECIFICATIONS REFERENCED FOR COMPLIANCE.
 - TREES TO BE RELOCATED ARE REQUIRED TO HAVE THEIR ROOTS PRUNED 8 WEEKS PRIOR TO BEING RELOCATED.
 - TREES TO BE RELOCATED MAY BE MOVED ONLY ONCE FROM THEIR EXISTING SPOT TO A FINAL LOCATION. NO NURSERY OR HOLDING AREAS ARE ALLOWED.
 - ALL TREE WORK TO BE PERFORMED BY ACCREDITED ARBORIST
 - PROPER GRADING TO TAKE PLACE AT FINAL RELOCATION AREAS TO BE DONE PRIOR TO RELOCATION.
 - TEMPORARY IRRIGATION TO BE PREPARED PER SPECIFICATIONS FOR RELOCATED TREES PRIOR TO MOVE.
 - NO DEMOLITION TO OCCUR IN CLOSE PROXIMITY OF RELOCATED TREES PRIOR TO ROOT PRUNING/ FENCING.
 - THE FOLLOWING PRUNING TECHNIQUES ARE TO BE PERFORMED BY A CERTIFIED ARBORIST: DEAD WOOD PRUNING/DAMAGED LATERAL PRUNING, CROSS BRANCH PRUNING, RAISING OF CANOPY (AS SPECIFIED FOR SITE LIGHTING IMPROVEMENT FOR BIRDBIRDS) (AS SPECIFIED).
 - ADEQUATE WATER THROUGH CONSTRUCTION WITH TEMPORARY/ PERMANENT WATERING SYSTEM.
 - MAINTENANCE OF TREE PROTECTION FENCING UNTIL GRAND OPENING OR APPROVAL IN WRITING TO REMOVE FENCING BY LANDSCAPE ARCHITECT.

This document, together with the concepts and designs presented herein, is intended only for the specific purpose and client for which it was prepared. Release of any information contained herein without the written authorization and signature of Kimley-Horn and Associates, Inc. shall be without liability to Kimley-Horn and Associates, Inc.


Kimley-Horn and Associates, Inc. 2015 Kimley-Horn and Associates, Inc. 445 24th Street, Suite 200, Vero Beach, FL 32960 Phone: 772-781-4100 www.kimley-horn.com CA 00006966

Kimley-Horn


LANDSCAPE PLAN

Walmart STORE #4563-00 DANIA BEACH, FL WAL-MART STORES EAST, LP DANIA BEACH

DATE: 10/22/14
PROJECT NO: 147253678
SHEET NUMBER: 6500


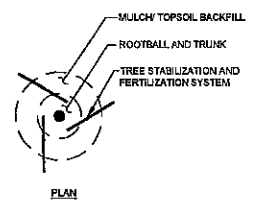


1. TREE WRAP.
2. 4" MINIMUM OF HARDWOOD MULCH COMPACTED OR AS SPECIFIED.
3. STAKE SIZE SHALL BE ONE SIZE HIGHER THAN REQUIRED FOR SIZE OF TREE. REFER TO SITEWORK SPECIFICATIONS FOR APPROVED MATERIALS AND INSTALLATION REQUIREMENTS.
4. 3" HIGH SOIL BERM TO HOLD WATER.
5. FINISHED GRADE (SEE GRADING PLAN).
6. TOP OF ROOTBALL MIN. 1" ABOVE FINISHED GRADE.
7. B & B OR CONTAINERIZED (SEE SPECIFICATIONS FOR ROOTBALL REQUIREMENTS).
8. PREPARED PLANTING SOIL AS SPECIFIED.
9. ROOTBALLS GREATER THAN 24" DIAMETER SHALL BE PLACED ON MOUND OF UNDISTURBED SOIL TO PREVENT SETTLING. ROOTBALLS SMALLER THAN 24" IN DIA. MAY SIT ON COMPACTED EARTH.
10. UNDISTURBED SUBSOIL.

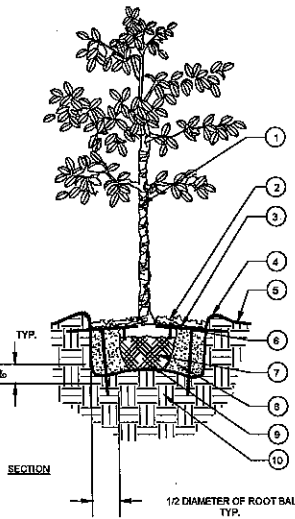



LARGE TREE PLANTING (14' OR GREATER)

- NOTES:
- A. FINAL TREE STAKING DETAILS AND PLACEMENT TO BE APPROVED BY OWNER.
 - B. REMOVE BURLAP, WIRE AND STRAPS (ANYTHING THAT COULD GIRDLE TREE OR RESTRICT ROOT GROWTH) ON UPPER 1/3 OF ROOTBALL.
 - C. SEE LANDSCAPE NOTES FOR THE TYPE OF MULCH MATERIAL TO USE.
 - D. PRUNE TREE AS DIRECTED BY LANDSCAPE ARCHITECT.
 - E. BRANCHING HEIGHT TO A.A.N. STANDARDS.

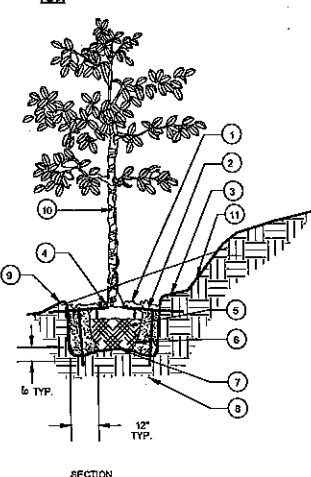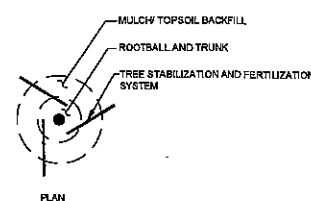


TREE PLANTING ON SLOPE

- NOTES:
- A. FINAL TREE STAKING DETAILS AND PLACEMENT TO BE APPROVED BY OWNER.
 - B. REMOVE BURLAP, WIRE AND STRAPS (ANYTHING THAT COULD GIRDLE TREE OR RESTRICT ROOT GROWTH) ON UPPER 1/3 OF ROOTBALL.
 - C. SEE LANDSCAPE NOTES FOR THE TYPE OF MULCH MATERIAL TO USE.
 - D. PRUNE TREE AS DIRECTED BY LANDSCAPE ARCHITECT.
 - E. BRANCHING HEIGHT TO A.A.N. STANDARDS.

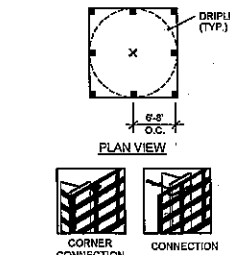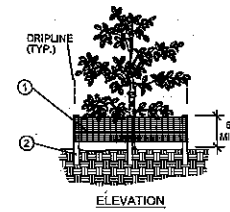


TREE/SHRUB PROTECTOR

1. "PERIMETER PLUS" CONSTRUCTION FENCE BY CORNED PLASTICS OR OWNER'S REPRESENTATIVE APPROVED EQUAL. SUBMIT PRODUCT INFORMATION FOR APPROVAL PRIOR TO INSTALLATION.
 2. 8" TALL METAL "T" POSTS OR 2" X 2" X 8" PRESSURE TREATED WOOD POSTS WITH 24" BURIAL BELOW GRADE.
- INSTALLATION NOTES:
- A. POST SELECTION SHOULD BE BASED ON EXPECTED STRENGTH NEEDS AND THE LENGTH OF TIME FENCE WILL BE IN PLACE. FLEXIBLE FIBERGLASS ROD POSTS ARE RECOMMENDED FOR PARKS, ATHLETIC EVENTS AND CROWD CONTROL INSTALLATIONS. METAL "T" POSTS OR TREATED WOOD POSTS ARE TYPICALLY USED FOR CONSTRUCTION AND OTHER APPLICATIONS.
 - B. POSTS SHOULD BE DRIVEN INTO THE GROUND TO A DEPTH OF 1/4 OF THE HEIGHT OF THE POST. FOR EXAMPLE, A 5' POST SHOULD BE SET AT LEAST 2" INTO THE GROUND.
 - C. SPACE POSTS EVERY 8' (MIN) TO 8' (MAX).
 - D. SECURE FENCING TO POST WITH NYLON CABLE TIES (AVAILABLE FROM CORNED PLASTICS). WOOD STRIPS MAY ALSO BE USED TO PROVIDE ADDITIONAL SUPPORT AND PROTECTION BETWEEN TIES AND POSTS.
- NOTE: IF WIRE TIES ARE USED, AVOID DIRECT CONTACT WITH FENCE. WIRE MAY DAMAGE FENCE OVER TIME.
- NOTE: UTILIZE TREE PROTECTION FENCE DETAILS ON TREE INVENTORY PLAN FOR EXISTING TREE PROTECTION.

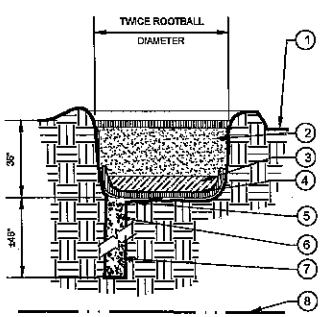


POOR DRAINAGE CONDITION

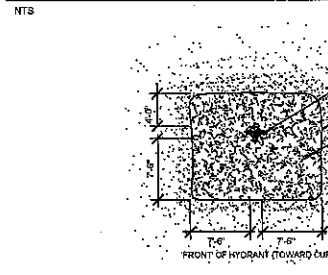


1. FIRE HYDRANT
2. NO PLANT MATERIAL SHALL BE PLACED WITHIN SHOWN RADIUS OF ALL PROPOSED OR EXISTING FIRE HYDRANTS. CONTRACTOR SHALL ADJUST PLANT MATERIAL SO THAT NO CONFLICTS WITH FIRE HYDRANTS OCCUR ON SITE.
3. PROVIDE A MULCH, 4" DEPTH MIN. SURROUNDING AREA INDICATED.

FIRE HYDRANT CLEAR ZONE

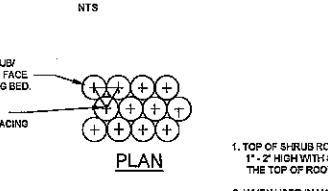


1. TOP OF SHRUB ROOTBALLS TO BE PLANTED 1" - 2" HIGH WITH SOIL MOUNDING UP TO THE TOP OF ROOTBALL.
2. WHEN USED IN MASSES-PRUNE ALL SHRUBS TO ACHIEVE A UNIFORM MASS HEIGHT.
3. 4" MINIMUM OF HARDWOOD BARK MULCH COMPACTED OR AS SPECIFIED.
4. EXCAVATE ENTIRE BED SPECIFIED FOR GROUND COVER BED.
5. 4" MINIMUM OF TOPSOIL TO BRING TO FINISHED GRADE (SEE GRADING PLAN).
6. PREPARED PLANTING SOIL AS SPECIFIED. NOTE: WHEN GROUND COVERS AND SHRUBS USED IN MASSES ENTIRE BED TO BE AMENDED WITH PLANTING SOIL MIX AS SPECIFIED.
7. SCARIFY ROOTBALL SIDES AND BOTTOM.

SHRUB/ GROUND COVER PLANTING

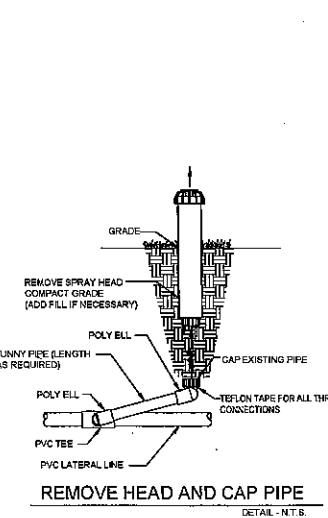


REMOVE HEAD AND CAP PIPE

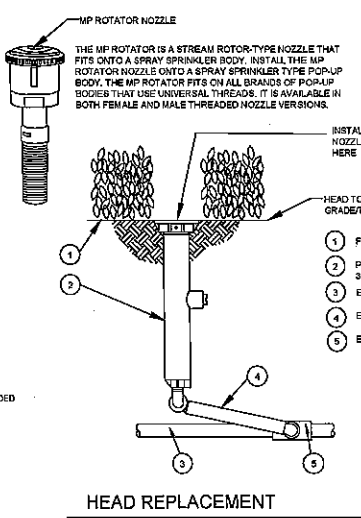


HEAD REPLACEMENT

PIPE SIZE	SLEEVE SIZE
3/4"	1-1/4"
1"	2"
1-1/4"	2-1/2"
1-1/2"	2-1/2"
2"	3"
2-1/2"	4"
3, 4"	6"

SLEEVE SIZE SCHEDULE

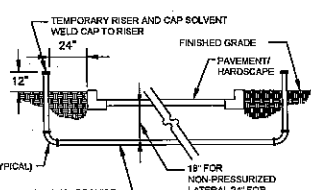


SLEEVE INSTALLATION

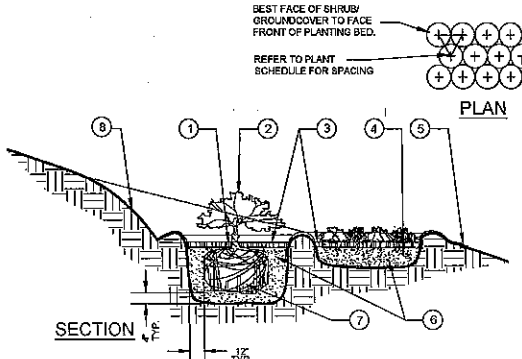


SHRUB/ GROUND COVER PLANTING ON SLOPE

1. TOP OF SHRUB ROOTBALLS TO BE PLANTED 1" - 2" HIGH WITH SOIL MOUNDING UP TO THE TOP OF ROOTBALL.
2. WHEN USED IN MASSES-PRUNE ALL SHRUBS TO ACHIEVE A UNIFORM MASS HEIGHT.
3. 4" MINIMUM OF SHREDDED HARDWOOD MULCH COMPACTED OR AS SPECIFIED.
4. EXCAVATE ENTIRE BED SPECIFIED FOR GROUND COVER BED.
5. 4" MINIMUM OF TOPSOIL TO BRING TO FINISHED GRADE (SEE GRADING PLAN).
6. PREPARED PLANTING SOIL MIX AS SPECIFIED. NOTE: WHEN GROUND COVERS AND SHRUBS USED IN MASSES ENTIRE BED TO BE AMENDED WITH PLANTING SOIL MIX AS SPECIFIED.
7. SCARIFY ROOTBALL SIDES AND BOTTOM.
8. CUT BACK SLOPE TO PROVIDE A FLAT SURFACE FOR PLANTING.

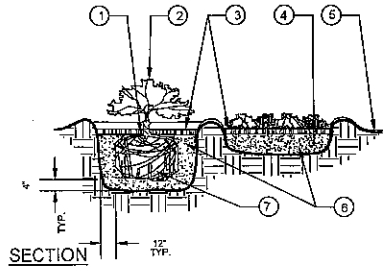


SHRUB/ GROUND COVER PLANTING

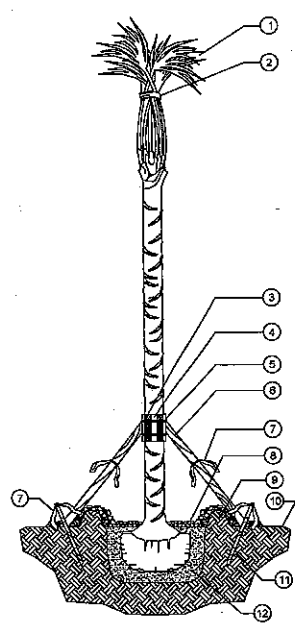


PALM TREE PLANTING


1. MINIMUM OF NINE (9) GOOD PALM FRONDS
 2. PRUNE AND TRIM FRONDS WITH HEMP TRUNK CUTTING PALMS TO BE "HURRICANE CUT"
 3. 5 LAYERS OF BURLAP TO PROTECT TRUNK.
 4. FIVE 2" X 4" X 18" WOOD BATTENS.
 5. SECURE BATTENS WITH 2-3/4" CARBON STEEL BANDS TO HOLD BATTENS IN PLACE. NO NAILS SHALL BE DRIVEN INTO PALM. HEIGHT OF BATTENS SHALL BE LOCATED IN RELATION TO THE HEIGHT OF THE PALM FOR ADEQUATE BRACING.
 6. ATTACH 3/2" X 4" X 8" DRILL AND NAIL (IF NECESSARY) TO BATTENS AND 2" X 4" STAKES. FLAG AT MIDPOINT AND AT BASE.
 7. PROVIDE FLAGGING.
 8. 4" SPECIFIED MULCH
 9. BERM SOIL TO HOLD WATER
 10. FINISH GRADE
 11. 2" X 4" X 24" (MIN) P.T. WOOD STAKES
 12. PREPARED PLANTING SOIL MIX AS SPECIFIED. COMPACT BENEATH ROOTBALL.
- NOTES:
- A. FINAL TREE STAKING DETAILS AND PLACEMENT TO BE APPROVED BY OWNER.
 - B. REMOVE BURLAP, WIRE AND STRAPS (ANYTHING THAT COULD GIRDLE TREE OR RESTRICT ROOT GROWTH) ON UPPER 1/3 OF ROOTBALL.
 - C. SEE LANDSCAPE NOTES FOR THE TYPE OF MULCH MATERIAL TO USE.

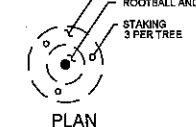

PALM TREE PLANTING

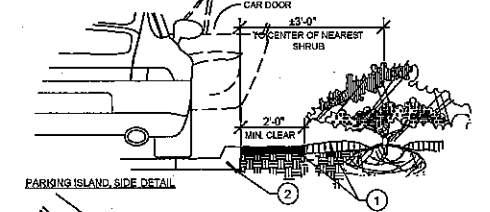


PARKING ISLAND, SIDE DETAIL

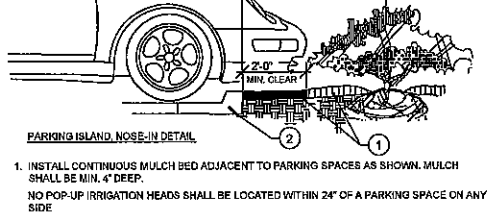


PARKING ISLAND, NOSE-IN DETAIL

1. INSTALL CONTINUOUS MULCH BED ADJACENT TO PARKING SPACES AS SHOWN. MULCH SHALL BE MIN. 4" DEEP.
2. CURB OR PARKING LOT EDGE, BY OTHERS

PARKING SPACE/CURB PLANTING

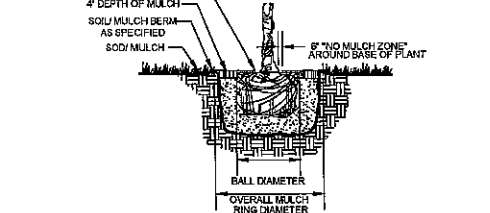

MULCH DETAIL FOR TREE AND SHRUB PLANTINGS

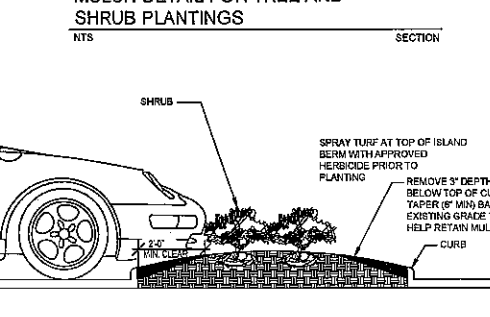

MULCH TAPER DETAIL

Kimley-Horn
 LANDSCAPE ARCHITECTS AND ASSOCIATES, INC.
 1450 24TH STREET, SUITE 200, VERO BEACH, FL 32960
 PHONE: 772-754-4100
 WWW.KIMLEY-HORN.COM CA 00000856



DESIGNED BY: MTF
 DRAWN BY: MTF
 CHECKED BY: DAS
 DATE: JUN 17 2015

LANDSCAPE AND IRRIGATION DETAILS

Walmart STORE #4563-00
 DANIA BEACH, FL
 WAL-MART STORES EAST, LP
 DANIA BEACH

DATE: 10/22/14
 PROJECT NO. 147253678
 SHEET NUMBER

6510

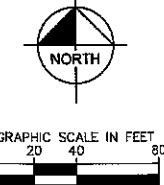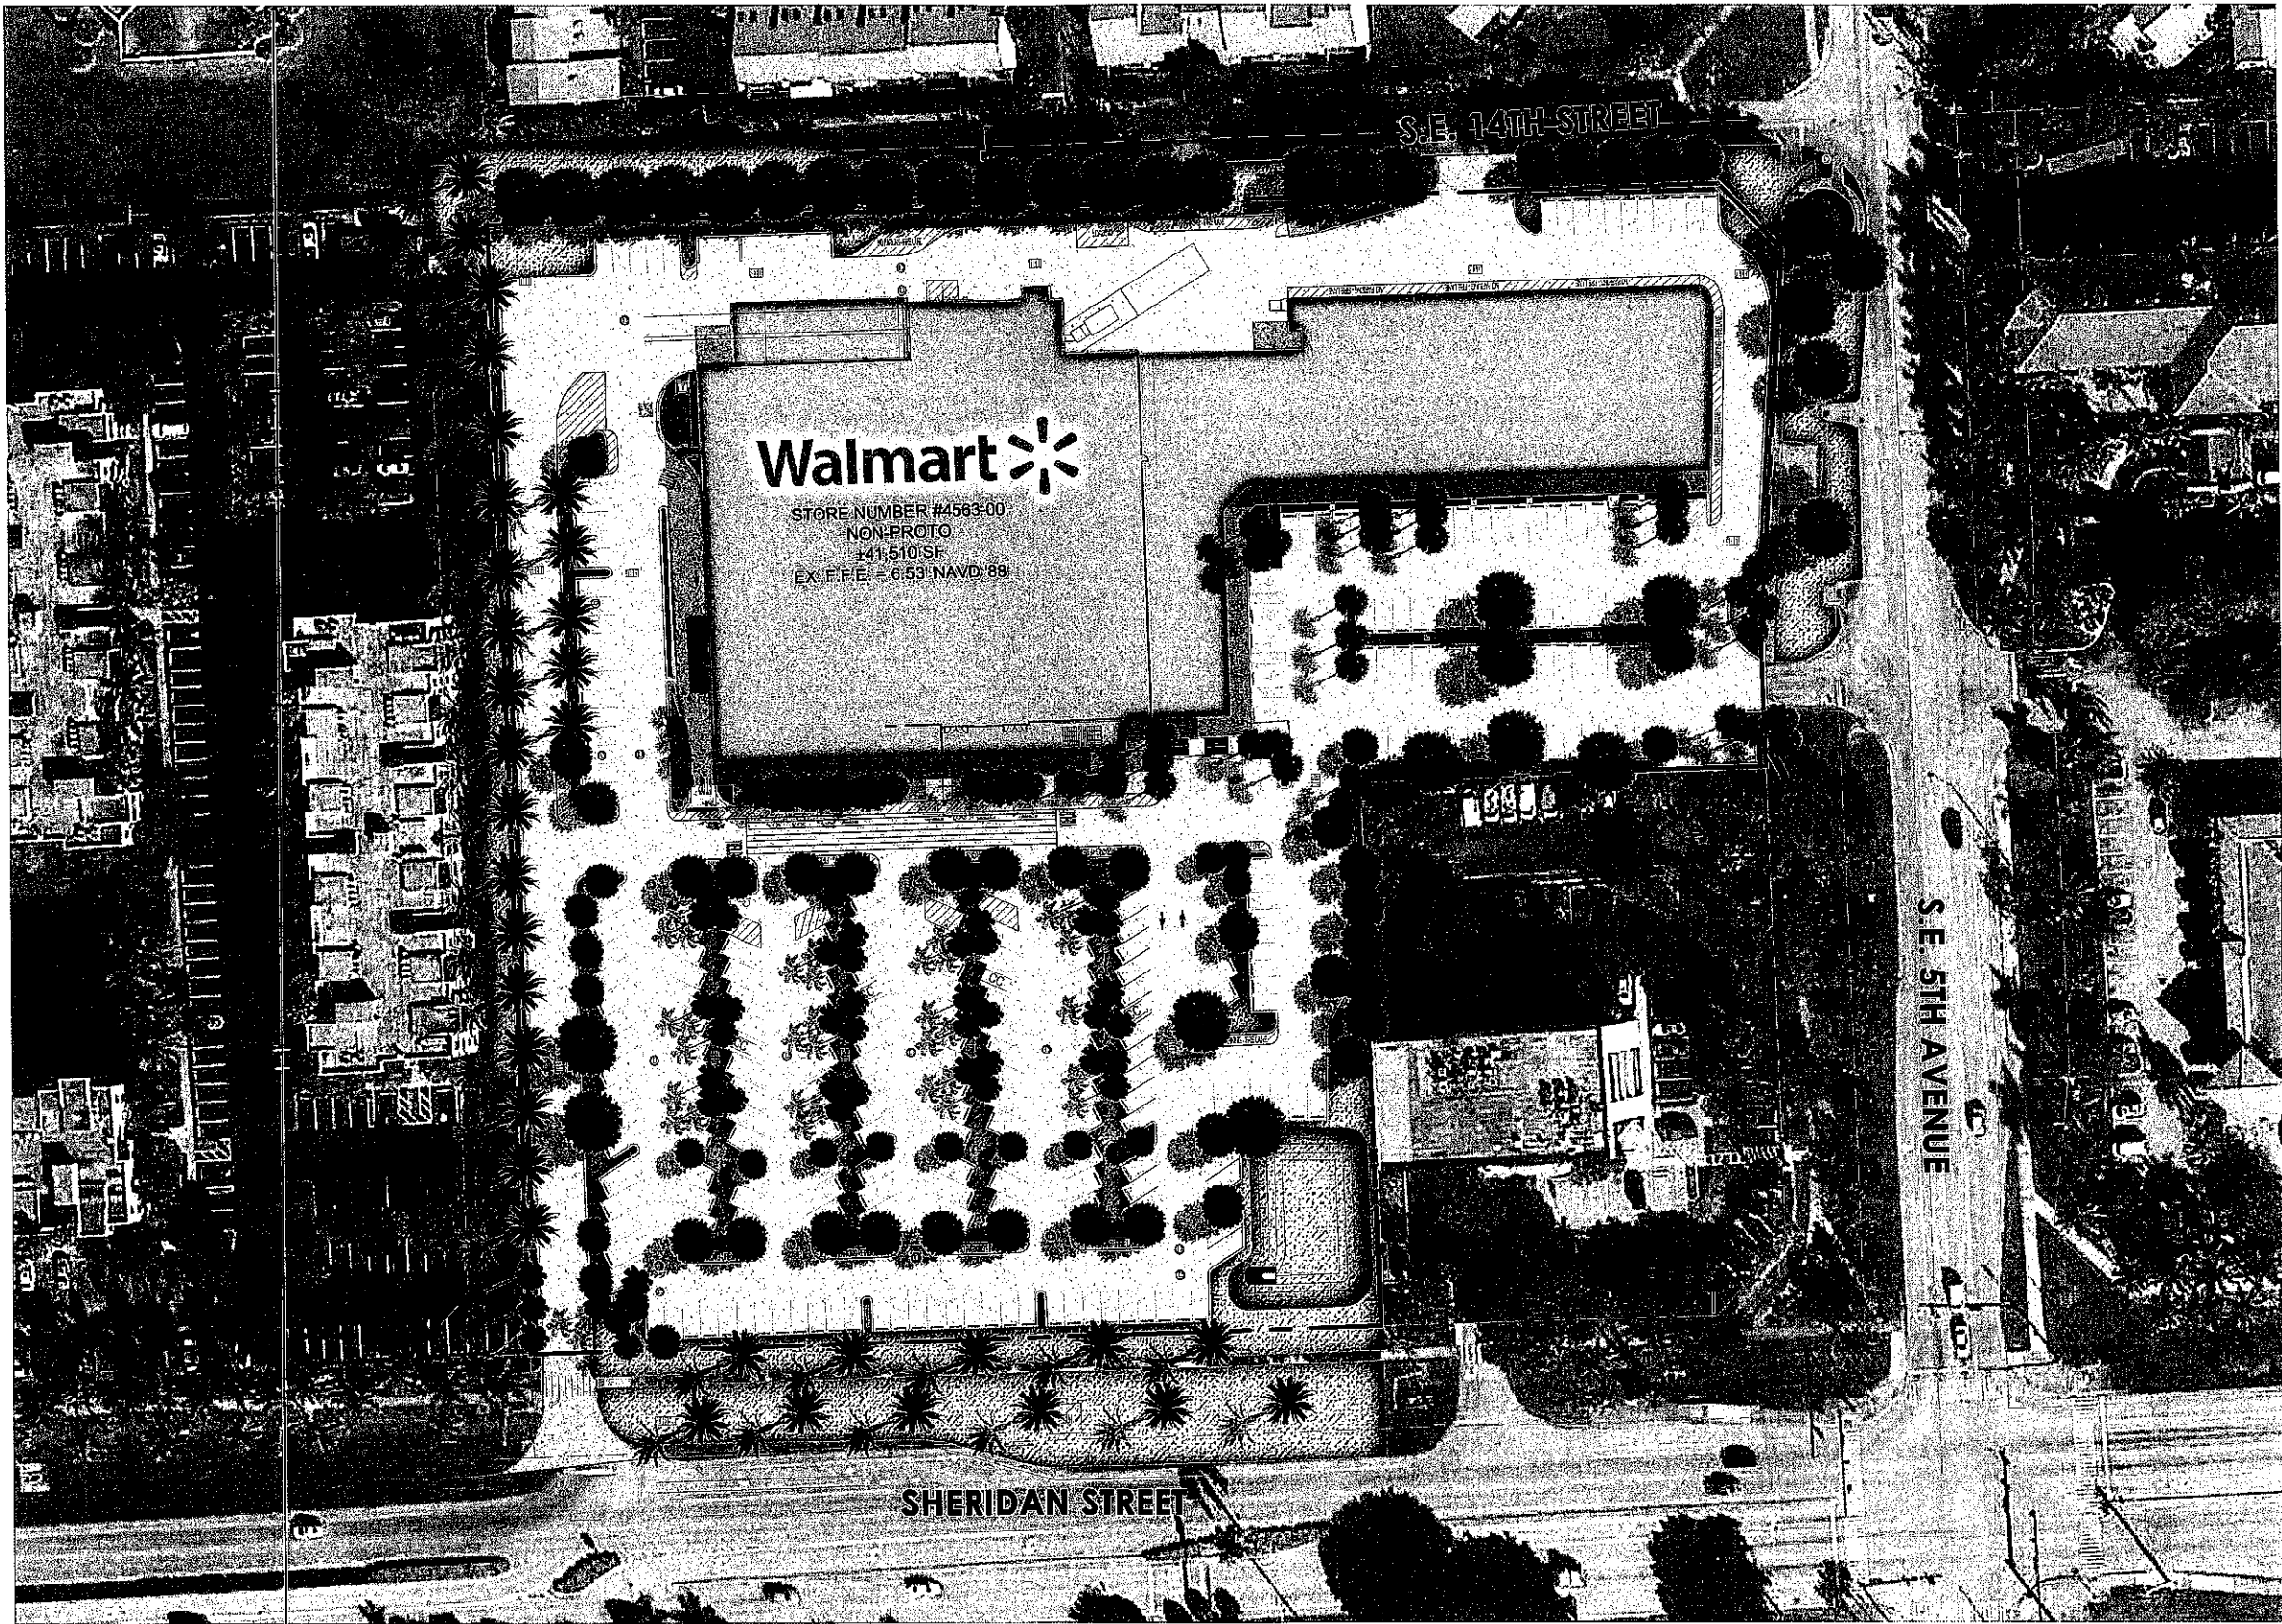

Walmart - Dania Beach
Sheridan Street & 5th Avenue
June 2015

Kimley»Horn

